

09/06/14

See Sheet 1-A For Index of Sheets

STATE OF NORTH CAROLINA
DIVISION OF HIGHWAYS

BLADEN COUNTY




LOCATION: BRIDGE NO. 124 OVER PHILLIPS CREEK ON SR 1318 (RIVER RD.)

TYPE OF WORK: GRADING, DRAINAGE, PAVING & CULVERT

STATE	STATE PROJECT REFERENCE NO.	SHEET NO.	TOTAL SHEETS
N.C.	B-5411	1	
STATE PROJ. NO.	F.A. PROJ. NO.	DESCRIPTION	
45427.1.1	BRZ-1318(13)	PE	
45427.2.1	BRZ-1318(13)	R/W & UTIL.	
45427.3.1	BRZ-1318(13)	CONST.	

TIP PROJECT: B-5411

CONTRACT: DF-00071

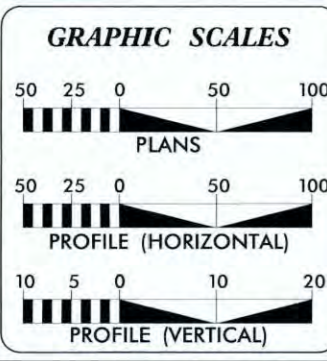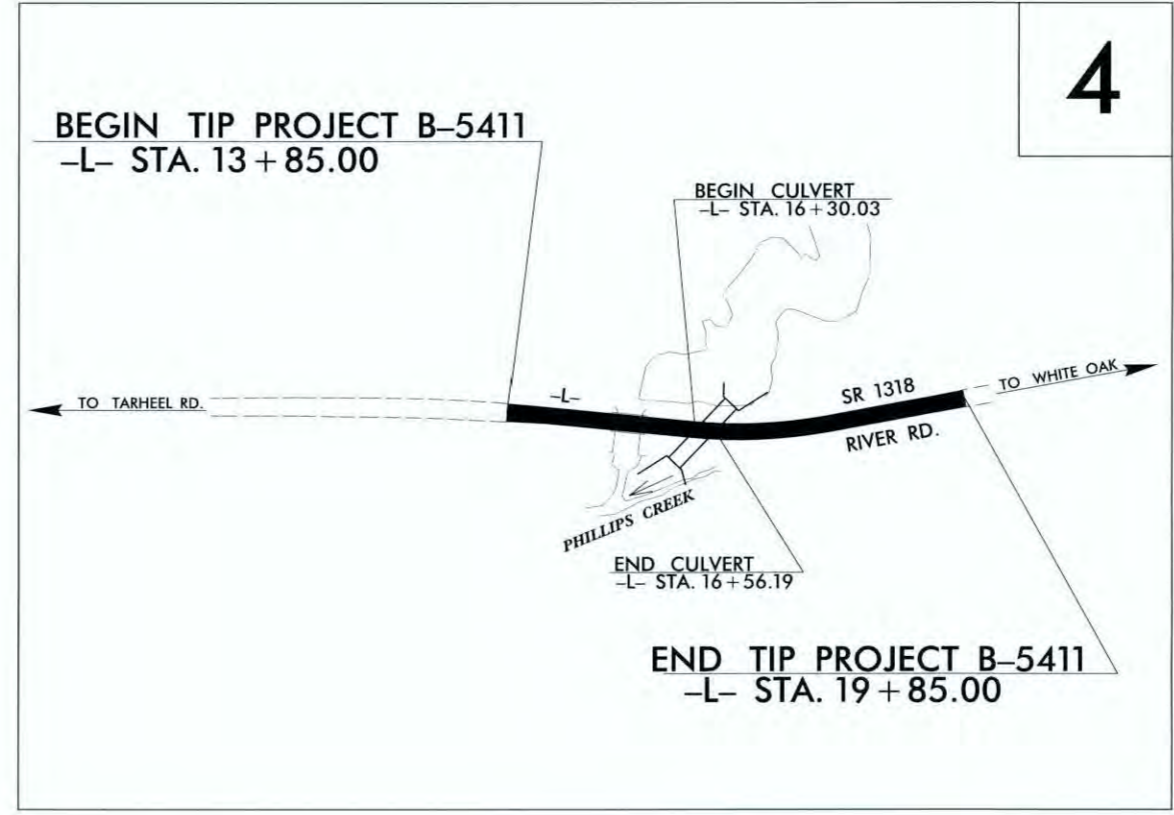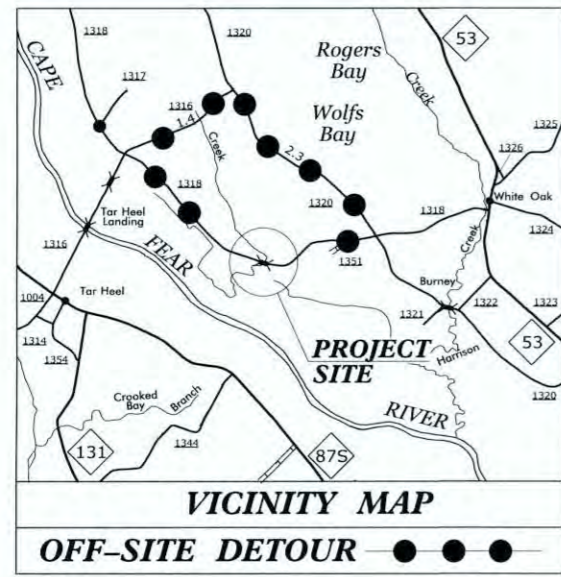

DESIGN DATA

ADT 2011 = 2300
ADT 2031 = 4155

DHV = 10 %
D = 50 %
T = 8 % *
V = 55 MPH

* TTST = 3% DUAL 5%
FUNC CLASS =
RURAL LOCAL
SUBREGIONAL TIER

PROJECT LENGTH

LENGTH ROADWAY TIP PROJECT B-5411 = 0.109 MILES
LENGTH STRUCTURE TIP PROJECT B-5411 = 0.005 MILES
TOTAL LENGTH TIP PROJECT B-5411 = 0.114 MILES

Prepared for the North Carolina Department of Transportation in the Office of:
559 JONES FRANKLIN ROAD
RALEIGH, N.C. 27606
Licence No. P-0377
Fax: 919 851 8107

ETHERILL ENGINEERING

2012 STANDARD SPECIFICATIONS

RIGHT OF WAY DATE: EDWARD G. WETHERILL, PE
PROJECT ENGINEER

LETTING DATE: GREG S. PURVIS, PE
PROJECT DESIGN ENGINEER

HYDRAULICS ENGINEER

SEAL
023983
MAX S. PRICE
6/9/14
P.E.

ROADWAY DESIGN ENGINEER

SEAL
022999
GREG S. PURVIS
6/9/14
P.E.



13/2/03: PM
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 6/9/2014



GENERAL NOTES

GENERAL NOTES: 2012 SPECIFICATIONS
 EFFECTIVE: 01-17-12
 REVISED: 07-30-2012

GRADING AND SURFACING OR RESURFACING AND WIDENING:

THE GRADE LINES SHOWN DENOTE THE FINISHED ELEVATION OF THE PROPOSED SURFACING AT GRADE POINTS SHOWN ON THE TYPICAL SECTIONS. WHERE NO GRADE LINES ARE SHOWN, THE PROFILES SHOWN DENOTE THE TOP ELEVATION OF THE EXISTING PAVEMENT ALONG THE CENTER LINE OF SURVEY ON WHICH THE PROPOSED RESURFACING WILL BE PLACED. GRADE LINES MAY BE ADJUSTED BY THE ENGINEER IN ORDER TO SECURE A PROPER TIE-IN.

CLEARING:

CLEARING ON THIS PROJECT SHALL BE PERFORMED TO THE LIMITS ESTABLISHED BY METHOD II.

SUPERELEVATION:

ALL CURVES ON THIS PROJECT SHALL BE SUPERELEVATED IN ACCORDANCE WITH STD. NO. 225.04 USING THE RATE OF SUPERELEVATION AND RUNOFF SHOWN ON THE PLANS. SUPERELEVATION IS TO BE REVOLVED ABOUT THE GRADE POINTS SHOWN ON THE TYPICAL SECTIONS.

SHOULDER CONSTRUCTION:

ASPHALT, EARTH, AND CONCRETE SHOULDER CONSTRUCTION ON THE HIGH SIDE OF SUPERELEVATED CURVES SHALL BE IN ACCORDANCE WITH STD. NO. 560.01.

GUARDRAIL:

THE GUARDRAIL LOCATIONS SHOWN ON THE PLANS MAY BE ADJUSTED DURING CONSTRUCTION AS DIRECTED BY THE ENGINEER. THE CONTRACTOR SHOULD CONSULT WITH THE ENGINEER PRIOR TO ORDERING GUARDRAIL MATERIAL.

UTILITIES:

UTILITY OWNERS ON THIS PROJECT ARE FOUR COUNTY EMC (POWER TRANSMISSION & DISTRIBUTION), STAR TELEPHONE (PHONE) AND BLADEN COUNTY PUBLIC WORKS (WATER).

RIGHT OF WAY MARKERS:

ALL RIGHT OF WAY MARKERS ON THIS PROJECT SHALL BE PLACED BY CONTRACT.

LIST OF ROADWAY STANDARD DRAWINGS

EFF. 01-17-12
REV. 10-30-2012

2012 ROADWAY ENGLISH STANDARD DRAWINGS

The following Roadway Standards as appear in "Roadway Standard Drawings" Highway Design Branch - N. C. Department of Transportation - Raleigh, N. C., Dated January, 2012 are applicable to this project and by reference hereby are considered a part of these plans:

STD.NO.	TITLE
DIVISION 2 - EARTHWORK	
200.02	Method of Clearing - Method II
225.02	Guide for Grading Subgrade - Secondary and Local
225.04	Method of Obtaining Superelevation - Two Lane Pavement
DIVISION 5 - SUBGRADE, BASES AND SHOULDERS	
560.01	Method of Shoulder Construction - High Side of Superelevated Curve - Method I
DIVISION 8 - INCIDENTALS	
806.01	Concrete Right-of-Way Marker
806.02	Granite Right-of-Way Marker
862.01	Guardrail Placement
862.02	Guardrail Installation
876.01	Rip Rap in Channels

INDEX OF SHEETS

SHEET NUMBER	SHEET
1	TITLE SHEET
1-A	INDEX OF SHEETS, GENERAL NOTES, AND LIST OF STANDARD DRAWINGS
1-B	CONVENTIONAL SYMBOLS
2	TYPICAL SECTIONS, PAVEMENT SCHEDULE, & MISCELLANEOUS DETAILS
3	GUARDRAIL SUMMARY, EARTHWORK SUMMARY DRAINAGE SUMMARY, PAVEMENT REMOVAL SUMMARY AND RIGHT OF WAY AREA DATA PLAN & PROFILE SHEET
4	TRANSPORTATION MANAGEMENT PLANS
TMP-1 THRU TMP-4	PAVEMENT MARKING PLANS
PMP-1 THRU PMP-2	EROSION CONTROL PLANS
EC-1 THRU EC-6	UTILITIES CONSTRUCTION PLANS
UC-1 THRU UC-2	UTILITIES BY OTHERS PLANS
UO-1 THRU UO-2	CROSS-SECTION SUMMARY SHEET
X-1A	CROSS-SECTIONS
X-1 THRU X-6	CULVERT PLANS & CULVERT NOTES
C-1 THRU C-4	

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STATE OF NORTH CAROLINA
DIVISION OF HIGHWAYS

CONVENTIONAL PLAN SHEET SYMBOLS

Note: Not to Scale

*S.U.E. = Subsurface Utility Engineering

BOUNDARIES AND PROPERTY:

State Line	-----
County Line	-----
Township Line	-----
City Line	-----
Reservation Line	-----
Property Line	-----
Existing Iron Pin	○ EP
Property Corner	-----
Property Monument	□ ECM
Parcel/Sequence Number	⑫③
Existing Fence Line	-x-x-x-
Proposed Woven Wire Fence	○
Proposed Chain Link Fence	□
Proposed Barbed Wire Fence	◇
Existing Wetland Boundary	-WLB-
Proposed Wetland Boundary	-WLB-
Existing Endangered Animal Boundary	-EAB-
Existing Endangered Plant Boundary	-EPB-
Known Soil Contamination: Area or Site	☠ ☠
Potential Soil Contamination: Area or Site	☠ ?

BUILDINGS AND OTHER CULTURE:

Gas Pump Vent or U/G Tank Cap	○
Sign	○ S
Well	○ W
Small Mine	✕
Foundation	□
Area Outline	□
Cemetery	†
Building	□
School	□
Church	□
Dam	□

HYDROLOGY:

Stream or Body of Water	-----
Hydro, Pool or Reservoir	-----
Jurisdictional Stream	-JS-
Buffer Zone 1	-BZ 1-
Buffer Zone 2	-BZ 2-
Flow Arrow	←
Disappearing Stream	→
Spring	○
Wetland	-----
Proposed Lateral, Tail, Head Ditch	-----
False Sump	-----

RAILROADS:

Standard Gauge	-----
RR Signal Milepost	○
Switch	□
RR Abandoned	-----
RR Dismantled	-----

RIGHT OF WAY:

Baseline Control Point	◆
Existing Right of Way Marker	△
Existing Right of Way Line	-----
Proposed Right of Way Line	-----
Proposed Right of Way Line with Iron Pin and Cap Marker	-----
Proposed Right of Way Line with Concrete or Granite RW Marker	-----
Proposed Control of Access Line with Concrete C/A Marker	-----
Existing Control of Access	-----
Proposed Control of Access	-----
Existing Easement Line	-----
Proposed Temporary Construction Easement	-----
Proposed Temporary Drainage Easement	-----
Proposed Permanent Drainage Easement	-----
Proposed Permanent Drainage / Utility Easement	-----
Proposed Permanent Utility Easement	-----
Proposed Temporary Utility Easement	-----
Proposed Aerial Utility Easement	-----
Proposed Permanent Easement with Iron Pin and Cap Marker	-----

ROADS AND RELATED FEATURES:

Existing Edge of Pavement	-----
Existing Curb	-----
Proposed Slope Stakes Cut	-----
Proposed Slope Stakes Fill	-----
Proposed Curb Ramp	-----
Existing Metal Guardrail	-----
Proposed Guardrail	-----
Existing Cable Guiderail	-----
Proposed Cable Guiderail	-----
Equality Symbol	-----
Pavement Removal	-----
VEGETATION:	
Single Tree	☼
Single Shrub	☼
Hedge	-----
Woods Line	-----

Orchard	-----
Vineyard	-----

EXISTING STRUCTURES:

MAJOR:	
Bridge, Tunnel or Box Culvert	-----
Bridge Wing Wall, Head Wall and End Wall	-----
MINOR:	
Head and End Wall	-----
Pipe Culvert	-----
Footbridge	-----
Drainage Box: Catch Basin, DI or JB	-----
Paved Ditch Gutter	-----
Storm Sewer Manhole	-----
Storm Sewer	-----

UTILITIES:

POWER:	
Existing Power Pole	-----
Proposed Power Pole	-----
Existing Joint Use Pole	-----
Proposed Joint Use Pole	-----
Power Manhole	-----
Power Line Tower	-----
Power Transformer	-----
U/G Power Cable Hand Hole	-----
H-Frame Pole	-----
Recorded U/G Power Line	-----
Designated U/G Power Line (S.U.E.*)	-----

TELEPHONE:

Existing Telephone Pole	-----
Proposed Telephone Pole	-----
Telephone Manhole	-----
Telephone Booth	-----
Telephone Pedestal	-----
Telephone Cell Tower	-----
U/G Telephone Cable Hand Hole	-----
Recorded U/G Telephone Cable	-----
Designated U/G Telephone Cable (S.U.E.*)	-----
Recorded U/G Telephone Conduit	-----
Designated U/G Telephone Conduit (S.U.E.*)	-----
Recorded U/G Fiber Optics Cable	-----
Designated U/G Fiber Optics Cable (S.U.E.*)	-----

WATER:

Water Manhole	-----
Water Meter	-----
Water Valve	-----
Water Hydrant	-----
Recorded U/G Water Line	-----
Designated U/G Water Line (S.U.E.*)	-----
Above Ground Water Line	-----

TV:

TV Satellite Dish	-----
TV Pedestal	-----
TV Tower	-----
U/G TV Cable Hand Hole	-----
Recorded U/G TV Cable	-----
Designated U/G TV Cable (S.U.E.*)	-----
Recorded U/G Fiber Optic Cable	-----
Designated U/G Fiber Optic Cable (S.U.E.*)	-----

GAS:

Gas Valve	-----
Gas Meter	-----
Recorded U/G Gas Line	-----
Designated U/G Gas Line (S.U.E.*)	-----
Above Ground Gas Line	-----

SANITARY SEWER:

Sanitary Sewer Manhole	-----
Sanitary Sewer Cleanout	-----
U/G Sanitary Sewer Line	-----
Above Ground Sanitary Sewer	-----
Recorded SS Forced Main Line	-----
Designated SS Forced Main Line (S.U.E.*)	-----

MISCELLANEOUS:

Utility Pole	-----
Utility Pole with Base	-----
Utility Located Object	-----
Utility Traffic Signal Box	-----
Utility Unknown U/G Line	-----
U/G Tank; Water, Gas, Oil	-----
Underground Storage Tank, Approx. Loc.	-----
A/G Tank; Water, Gas, Oil	-----
Geoenvironmental Boring	-----
U/G Test Hole (S.U.E.*)	-----
Abandoned According to Utility Records	-----
End of Information	-----

6/2/94

PAVEMENT SCHEDULE (PRELIMINARY PAVEMENT DESIGN)	
C1	PROP. APPROX. 3" ASPHALT CONCRETE SURFACE COURSE, TYPE S9.5B, AT AN AVERAGE RATE OF 168 LBS. PER SQ. YD. IN EACH OF TWO LAYERS.
D1	PROP. APPROX. 2 1/2" ASPHALT CONCRETE INTERMEDIATE COURSE, TYPE I19.0B, AT AN AVERAGE RATE OF 285 LBS. PER SQ. YD.
E1	PROP. APPROX. 4" ASPHALT CONCRETE BASE COURSE, TYPE B25.0B, AT AN AVERAGE RATE OF 456 LBS. PER SQ. YD.
T	EARTH MATERIAL.


NOTE: PAVEMENT EDGE SLOPES ARE 1:1 UNLESS SHOWN OTHERWISE.

ROADWAY DESIGN ENGINEER

559 Jones Franklin Rd. Suite 164
Raleigh, N.C. 27606
License No. F-0377
Bus: 919 851 8077
Fax: 919 851 8107


WETHERILL ENGINEERING

TRANSPORTATION PLANNING/DESIGN - BRIDGE/STRUCTURE DESIGN
CIVIL/SITE DESIGN - GIS/GPS - CONSTRUCTION OBSERVATION

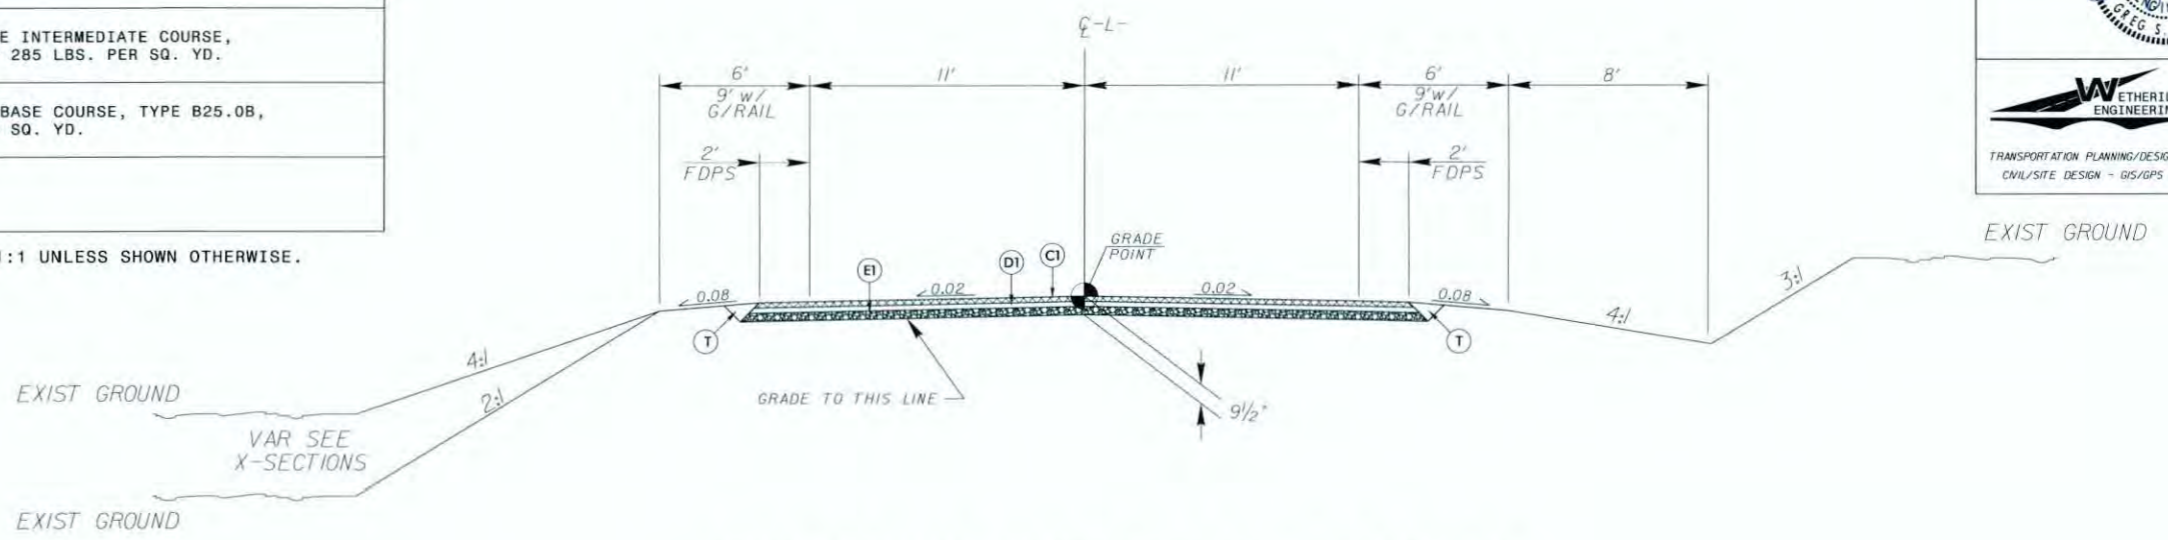


TYPICAL SECTION NO. 1

USE TYPICAL SECTION NO. 1:
FDPS = FULL DEPTH PAVED SHOULDER
-L- STA. 13+85.00 TO -L- STA. 19+85.00

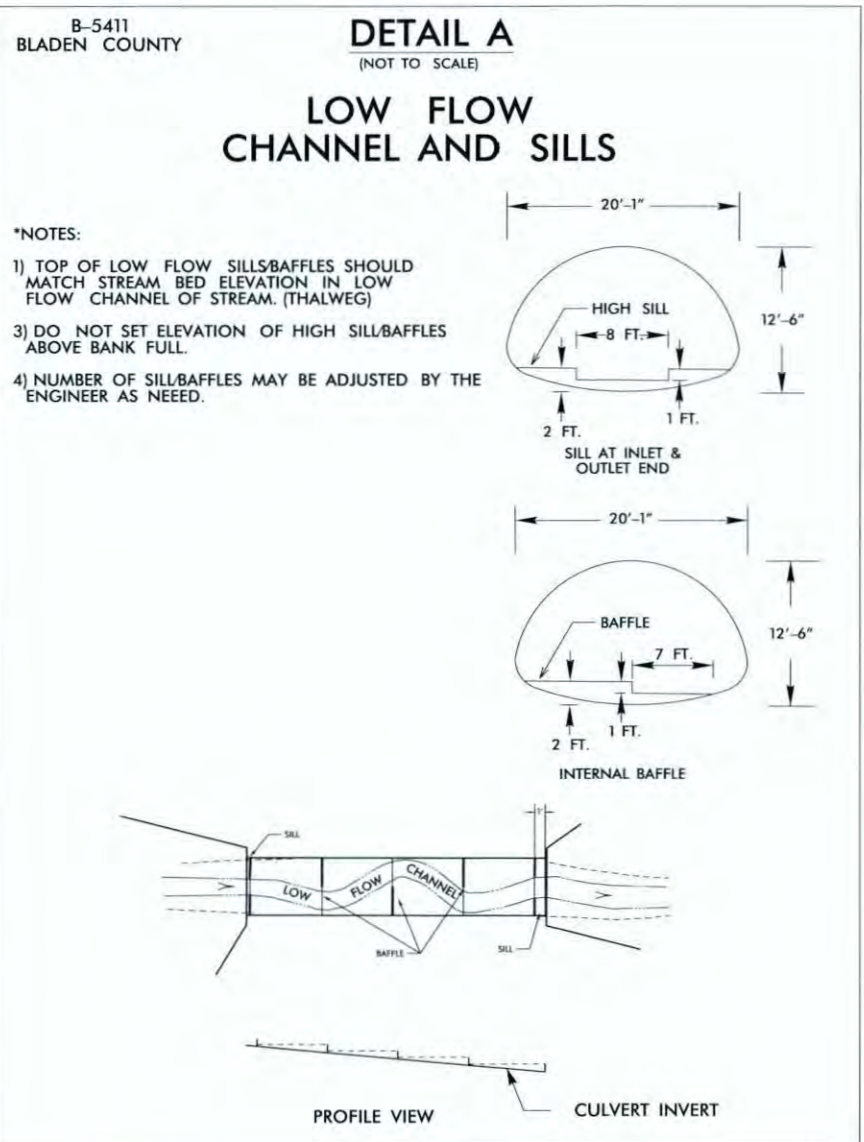




MILLING AT PAVEMENT TIE-INS

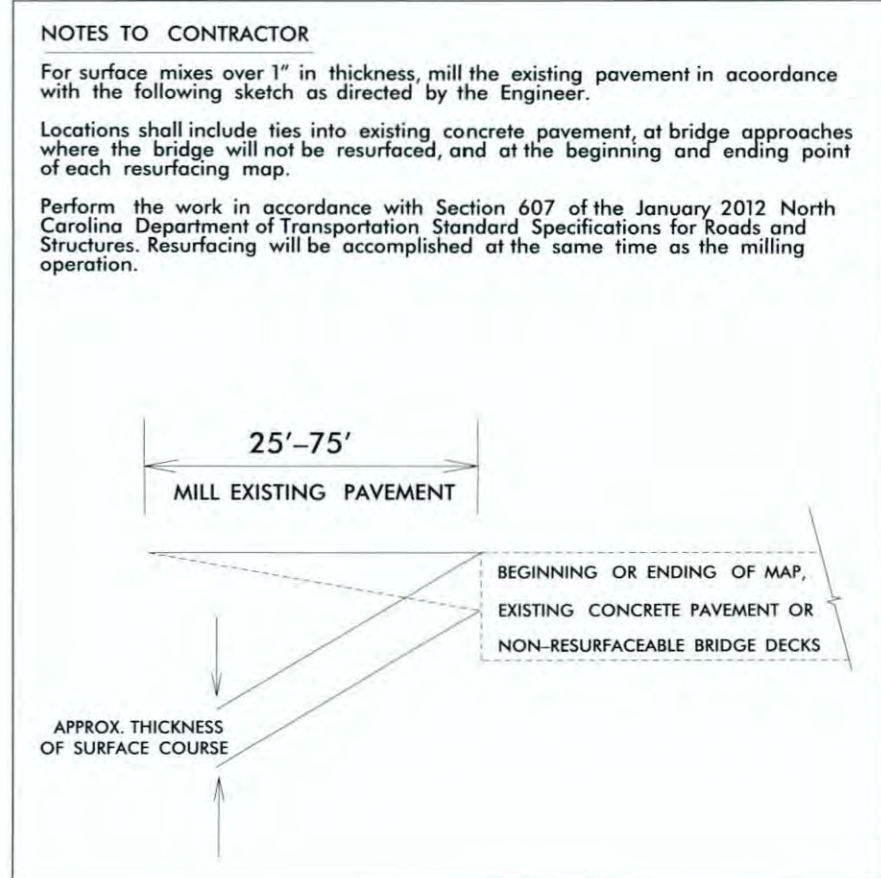

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PARCEL INDEX	
PARCEL NO.	PROPERTY OWNER NAME
1	ROCKING A RANCH, INC
2	ROCKING A RANCH, INC
3	ASTRAKEL INTERNATIONAL, LTD

PI Sta 13+21.69 $\Delta = 5^{\circ} 34' 02.1''$ (RT) $D = 2^{\circ} 05' 00.5''$ $L = 267.21'$ $T = 133.71'$ $R = 2750.00'$ $SE = EXIST.$ $RO = SEE PLANS$	PI Sta 17+15.83 $\Delta = 15^{\circ} 53' 18.9''$ (LT) $D = 8^{\circ} 48' 53.0''$ $L = 180.25'$ $T = 90.71'$ $R = 650.00'$ $SE = 0.06$ FT/FT $RO = SEE PLANS$
--	---

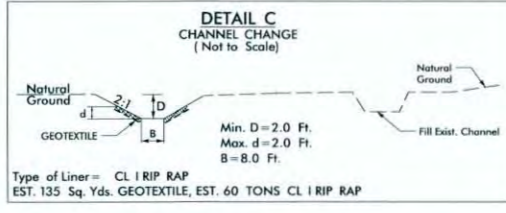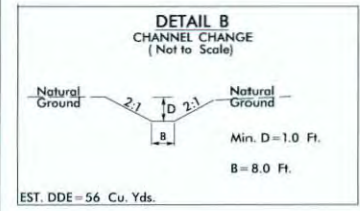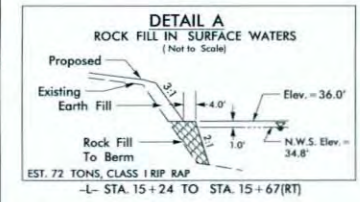

DATUM DESCRIPTION

THE LOCALIZED COORDINATE SYSTEM DEVELOPED FOR THIS PROJECT IS BASED ON THE STATE PLANE COORDINATES ESTABLISHED BY NCDOT FOR MONUMENT "B5411-2" WITH NAD 83/NA 2011 STATE PLANE GRID COORDINATES OF NORTHING: 360071.887(ft) EASTING: 2074424.528(ft) ELEVATION: 50.87(ft)

THE AVERAGE COMBINED GRID FACTOR USED ON THIS PROJECT (GROUND TO GRID) IS: 0.99991521


THE N.C. LAMBERT GRID BEARING AND LOCALIZED HORIZONTAL GRID DISTANCE FROM "B5411-2" TO -L- STATION 10+00.00 IS N 85° 9' 53" W 78.55'

ALL LINEAR DIMENSIONS ARE LOCALIZED HORIZONTAL DISTANCES VERTICAL DATUM USED IS NAVD 88

PIPE ARCH HYDRAULIC DATA

DESIGN DISCHARGE	= 800	CFS
DESIGN FREQUENCY	= 25	YRS
DESIGN HW ELEVATION	= 43.9	FT
BASE DISCHARGE	= 1,200	CFS
BASE FREQUENCY	= 100	YRS
BASE HW ELEVATION	= 45.93	FT
OVERTOPPING DISCHARGE	= > 1,700	CFS
OVERTOPPING FREQUENCY	= 500+	YRS
OVERTOPPING ELEVATION	= 53.0	FT

DATE OF SURVEY	= 11/13/12	
W.S.ELEVATION AT DATE OF SURVEY	= 40.7	FT

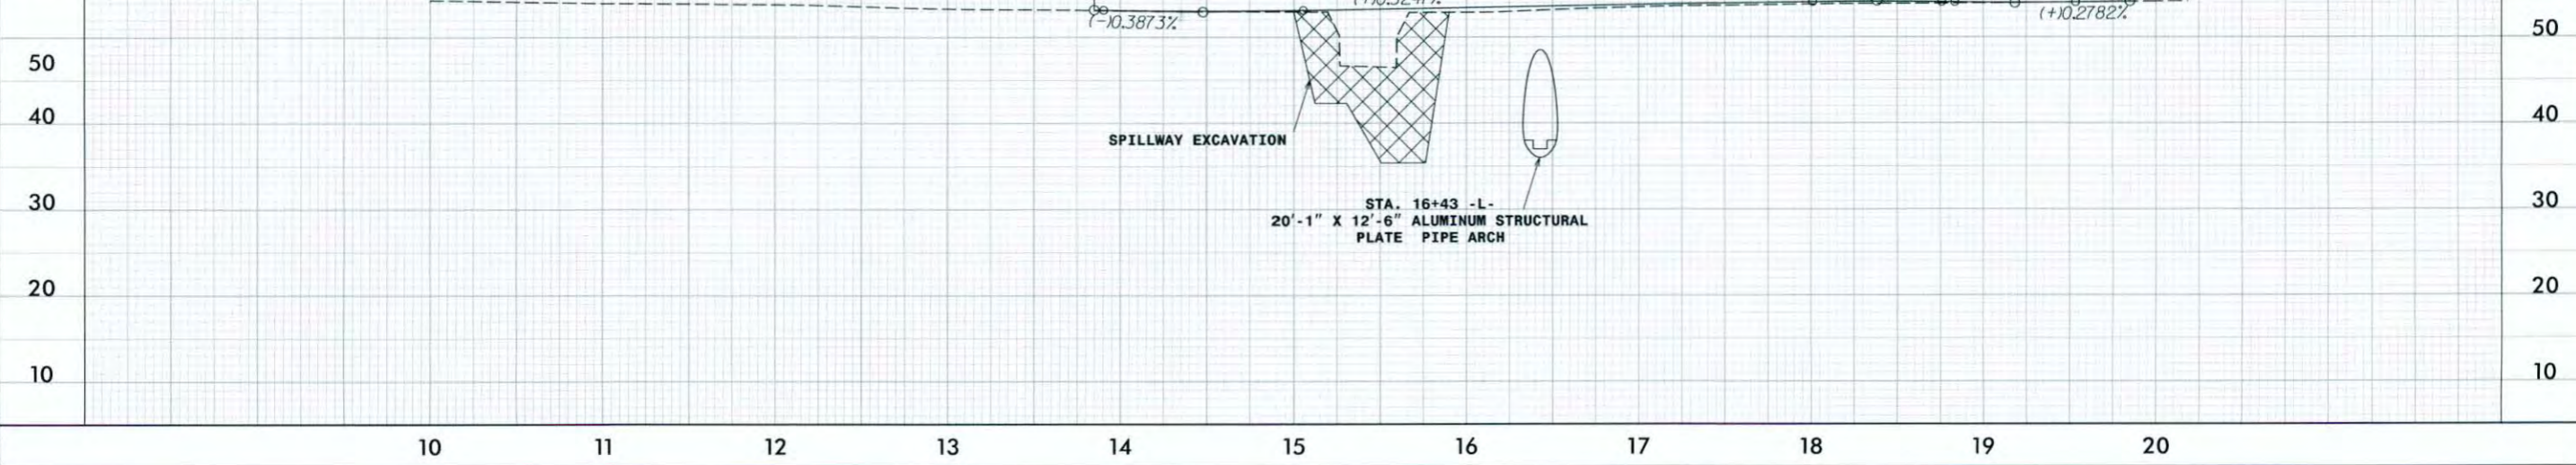


REVISIONS

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STATE OF NORTH CAROLINA
DIVISION OF HIGHWAYS

TRANSPORTATION MANAGEMENT PLAN

BLADEN COUNTY

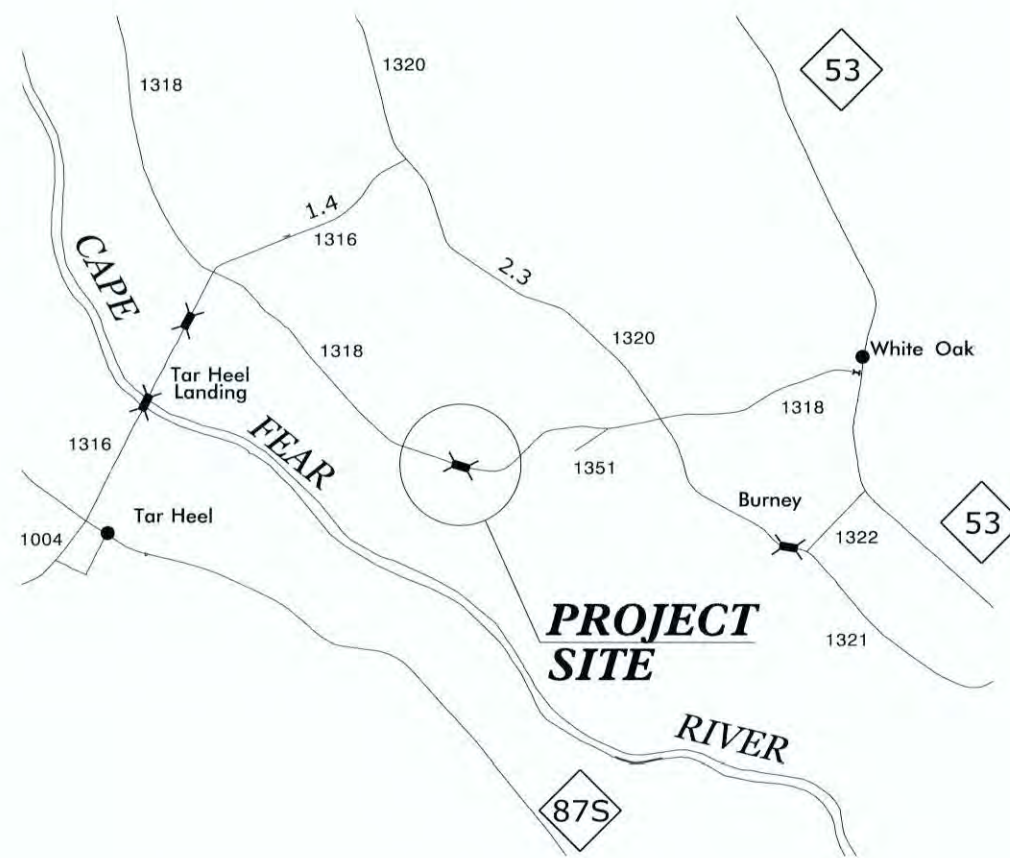

LOCATION: BRIDGE NO. 124 OVER CREEK ON SR 1318 (RIVER ROAD)

INDEX OF SHEETS

SHEET NO.	TITLE
TMP-1	TITLE SHEET, AND INDEX OF SHEETS
TMP-1A	LIST OF APPLICABLE ROADWAY STANDARD DRAWINGS, LEGEND, AND TEMPORARY PAVEMENT MARKING
TMP-1B	TRANSPORTATION OPERATIONS PLAN: (MANAGEMENT STRATEGIES, GENERAL NOTES AND LOCAL NOTES)
TMP-2	SIGN DESIGN DETAIL
TMP-3	TEMPORARY TRAFFIC CONTROL DETAIL AND PHASING
TMP-4	RIVER ROAD OFF-SITE DETOUR

SHEET NO.

TMP-1

B-5411


TIP PROJECT:



N.C.D.O.T. WORK ZONE TRAFFIC CONTROL
1561 MAIL SERVICE CENTER (MSC) RALEIGH, NC 27699-1561
750 N. GREENFIELD PARKWAY, GARNER, NC 27529 (DELIVERY)
PHONE: (919) 773-2800 FAX: (919) 771-2745

J. S. BOURNE, P.E. STATE TRAFFIC MANAGEMENT ENGINEER
J. S. KITE, P.E. TRAFFIC CONTROL PROJECT ENGINEER
TRAFFIC CONTROL PROJECT DESIGN ENGINEER
TRAFFIC CONTROL DESIGN ENGINEER



PLAN PREPARED FOR NCDOT BY:  WETHERILL ENGINEERING, INC.
GREG PURVIS, P.E. PROJECT ENGINEER
CHARLES MULLEN TRAFFIC CONTROL & PAVEMENT MARKING SPECIALIST

APPROVED:  DATE: 6/11/14
SEAL:  6/11/14

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ROADWAY STANDARD DRAWINGS

THE FOLLOWING ROADWAY STANDARDS AS SHOWN IN "ROADWAY STANDARD DRAWINGS" - PROJECT SERVICES UNIT - N.C. DEPARTMENT OF TRANSPORTATION - RALEIGH, N.C., DATED JANUARY 2012 ARE APPLICABLE TO THIS PROJECT AND BY REFERENCE HEREBY ARE CONSIDERED A PART OF THESE PLANS:

<u>STD. NO.</u>	<u>TITLE</u>
1101.03	TEMPORARY ROAD CLOSURES
1101.04	TEMPORARY SHOULDER CLOSURES
1101.05	WORK ZONE VEHICLE ACCESSES
1101.11	TRAFFIC CONTROL DESIGN TABLES
1110.01	STATIONARY WORK ZONE SIGNS
1110.02	PORTABLE WORK ZONE SIGNS
1135.01	CONES
1145.01	BARRICADES

LEGEND

GENERAL

- DIRECTION OF TRAFFIC FLOW
- EXIST. PVMT.
- NORTH ARROW
- PROPOSED PVMT.
- WORK AREA

TEMPORARY PAVEMENT MARKING

N/A

TRAFFIC CONTROL DEVICES

- BARRICADE (TYPE III)
- CONE

TEMPORARY SIGNING

- PORTABLE SIGN
- STATIONARY SIGN

PAVEMENT MARKINGS

- EXISTING LINES
- TEMPORARY LINES

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559 Jones Franklin Rd. Suite 164
Raleigh, N.C. 27606
License No. F-0377
Bus: 919 851 8077
Fax: 919 851 8107

TRANSPORTATION PLANNING/DESIGN - BRIDGE/STRUCTURE DESIGN
CIVIL/SITE DESIGN - GIS/GPS - CONSTRUCTION OBSERVATION

APPROVED: DATE: 6/9/14

GREG S. PURVIS
ENGINEER
22999

ROADWAY STANDARD
DRAWINGS & LEGEND

MANAGEMENT STRATEGIES

TRAFFIC OPERATIONS

SR 1318 (RIVER ROAD) WILL BE DETOURED OFF-SITE DURING REPLACEMENT OF THE EXISTING STRUCTURE USING ROADWAY STANDARD DRAWING 1101.03, SHEET 1 OF 9, AND TRAILBLAZE SIGNS.

THE OFF-SITE DETOUR ROUTING WILL BE AS FOLLOWS:

1. SR 1316 (TAR HEEL FERRY ROAD)
2. SR 1320 (BURNLEY ROAD)

LOCAL ACCESS TO ALL RESIDENCES AND BUSINESSES WILL BE MAINTAINED BETWEEN THE CLOSURE POINTS AT ALL TIMES DURING CONSTRUCTION.

NCDOT WILL FURNISH AND LOCATE CHANGEABLE MESSAGE BOARDS (CMB) FOR A 10-DAY ROAD CLOSURE NOTICE. THE CONTRACTOR SHALL NOTIFY THE DEPARTMENT A MINIMUM OF 30 DAYS PRIOR TO THE ACTUAL ROAD CLOSURE.

GENERAL NOTES / LOCAL NOTES

CHANGES MAY BE REQUIRED WHEN PHYSICAL DIMENSIONS IN THE DETAIL DRAWINGS, STANDARD DETAILS, AND ROADWAY DETAILS ARE NOT ATTAINABLE TO MEET FIELD CONDITIONS OR RESULT IN DUPLICATE OR UNDESired OVERLAPPING OF DEVICES. MODIFICATION MAY INCLUDE: MOVING, SUPPLEMENTING, COVERING, OR REMOVAL OF DEVICES AS DIRECTED BY THE ENGINEER.

THE FOLLOWING GENERAL NOTES APPLY AT ALL TIMES FOR THE DURATION OF THE CONSTRUCTION PROJECT EXCEPT WHEN OTHERWISE NOTED IN THE PLAN OR DIRECTED BY THE ENGINEER.

LANE AND SHOULDER CLOSURE REQUIREMENTS

- A) WHEN PERSONNEL AND/OR EQUIPMENT ARE WORKING WITHIN 15 FT OF AN OPEN TRAVEL LANE, CLOSE THE NEAREST OPEN SHOULDER USING ROADWAY STANDARD DRAWING NO. 1101.04 UNLESS THE WORK AREA IS PROTECTED BY BARRIER OR GUARDRAIL OR A LANE CLOSURE IS INSTALLED.

TRAFFIC PATTERN ALTERATIONS

- B) NOTIFY THE ENGINEER THIRTY (30) CALENDAR DAYS PRIOR TO ANY TRAFFIC PATTERN ALTERATION.

SIGNING

- C) PROVIDE SIGNING AND DEVICES REQUIRED TO CLOSE THE ROAD ACCORDING TO THE ROADWAY STANDARD DRAWINGS AND TRAFFIC CONTROL PLANS. PROVIDE SIGNING REQUIRED FOR THE OFF-SITE DETOUR ROUTE AS SHOWN IN THE TRAFFIC CONTROL PLANS.
- D) COVER OR REMOVE ALL SIGNS AND DEVICES REQUIRED TO CLOSE THE ROAD WHEN ROAD CLOSURE IS NOT IN OPERATION. COVER OR REMOVE ALL SIGNS REQUIRED FOR THE OFF-SITE DETOUR WHEN DETOUR IS NOT IN OPERATION.
- E) ENSURE ALL NECESSARY SIGNING IS IN PLACE PRIOR TO ALTERING ANY TRAFFIC PATTERN.

TRAFFIC CONTROL DEVICES

- F) PLACE TYPE III BARRICADES, WITH "ROAD CLOSED" SIGN R11-2 ATTACHED, OF SUFFICIENT LENGTH TO CLOSE ENTIRE ROADWAY.


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559 Jones Franklin Rd. Suite 164
Raleigh, N.C. 27606
License No. F-0377
Bus: 919 851 8077
Fax: 919 851 8107

TRANSPORTATION PLANNING/DESIGN - BRIDGE/STRUCTURE DESIGN
CIVIL/SITE DESIGN - GIS/GPS - CONSTRUCTION OBSERVATION

APPROVED: *Greg S. Purvis* DATE: 6/9/14



**TRANSPORTATION
OPERATIONS
PLAN**
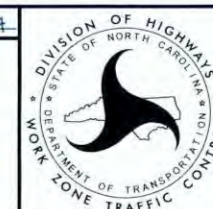
<p>SIGN NUMBER: SP BACKG COLOR: Fluorescent Orange TYPE: STATIONARY COPY COLOR: Color 239 QUANTITY: SEE PLANS <table border="1" style="display: inline-table; vertical-align: top;"> <thead> <tr> <th>SYMBOL</th> <th>X</th> <th>Y</th> <th>WID</th> <th>HT</th> </tr> </thead> <tbody> <tr><td> </td><td> </td><td> </td><td> </td><td> </td></tr> <tr><td> </td><td> </td><td> </td><td> </td><td> </td></tr> <tr><td> </td><td> </td><td> </td><td> </td><td> </td></tr> <tr><td> </td><td> </td><td> </td><td> </td><td> </td></tr> <tr><td> </td><td> </td><td> </td><td> </td><td> </td></tr> <tr><td> </td><td> </td><td> </td><td> </td><td> </td></tr> <tr><td> </td><td> </td><td> </td><td> </td><td> </td></tr> <tr><td> </td><td> </td><td> </td><td> </td><td> </td></tr> </tbody> </table> SIGN WIDTH: 2'-0" HEIGHT: 1'-0" TOTAL AREA: 2.0 Sq.Ft. BORDER TYPE: INSET RECESS: 0.31" WIDTH: 0.31" RADIO: 1.81" NO. Z BARS: LENGTH:</p>	SYMBOL	X	Y	WID	HT																																									<p>DESIGN BY: CLM CHECKED BY: GP DATE: Feb 20, 2013 PROJECT ID: B-5411 DIV: 6</p>																						
SYMBOL	X	Y	WID	HT																																																																
<table border="0"> <tr> <td style="text-align: center;"> <table border="1" style="border-collapse: collapse;"> <tr> <th>S</th><th>A</th><th>M</th><th>B</th><th>L</th><th>E</th><th>S</th> </tr> <tr> <td> </td><td> </td><td> </td><td> </td><td> </td><td> </td><td> </td> </tr> <tr> <td> </td><td> </td><td> </td><td> </td><td> </td><td> </td><td> </td> </tr> <tr> <td> </td><td> </td><td> </td><td> </td><td> </td><td> </td><td> </td> </tr> <tr> <td> </td><td> </td><td> </td><td> </td><td> </td><td> </td><td> </td> </tr> <tr> <td> </td><td> </td><td> </td><td> </td><td> </td><td> </td><td> </td> </tr> <tr> <td> </td><td> </td><td> </td><td> </td><td> </td><td> </td><td> </td> </tr> <tr> <td> </td><td> </td><td> </td><td> </td><td> </td><td> </td><td> </td> </tr> <tr> <td> </td><td> </td><td> </td><td> </td><td> </td><td> </td><td> </td> </tr> </table> </td> <td style="text-align: center; padding: 10px;"> </td> </tr> <tr> <td colspan="2" style="padding-top: 20px;"> <p>USE NOTES: 1,2</p> <ol style="list-style-type: none"> 1. Legend and border shall be direct applied black non-reflective sheeting. 2. Background shall be NC GRADE B fluorescent orange retroreflective sheeting. </td> </tr> </table>		<table border="1" style="border-collapse: collapse;"> <tr> <th>S</th><th>A</th><th>M</th><th>B</th><th>L</th><th>E</th><th>S</th> </tr> <tr> <td> </td><td> </td><td> </td><td> </td><td> </td><td> </td><td> </td> </tr> <tr> <td> </td><td> </td><td> </td><td> </td><td> </td><td> </td><td> </td> </tr> <tr> <td> </td><td> </td><td> </td><td> </td><td> </td><td> </td><td> </td> </tr> <tr> <td> </td><td> </td><td> </td><td> </td><td> </td><td> </td><td> </td> </tr> <tr> <td> </td><td> </td><td> </td><td> </td><td> </td><td> </td><td> </td> </tr> <tr> <td> </td><td> </td><td> </td><td> </td><td> </td><td> </td><td> </td> </tr> <tr> <td> </td><td> </td><td> </td><td> </td><td> </td><td> </td><td> </td> </tr> <tr> <td> </td><td> </td><td> </td><td> </td><td> </td><td> </td><td> </td> </tr> </table>	S	A	M	B	L	E	S																																																										<p>USE NOTES: 1,2</p> <ol style="list-style-type: none"> 1. Legend and border shall be direct applied black non-reflective sheeting. 2. Background shall be NC GRADE B fluorescent orange retroreflective sheeting. 	
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Spacing Factor is 1 unless specified otherwise

LETTER POSITIONS


Letter widths are shown														Series/Size	
														Text Length	
R	i	v	e	r		R	d								D 2000
2.7	0.6	2.8	2.4	1.5		2.7	2.4								18.4

FILENAME: Guidesign6 NORTH CAROLINA D.O.T. SIGN DETAIL

NOTE: TEMPORARY SIGN TO BE PAID FOR AS "STATIONARY WORK ZONE SIGNS"

6/9/2014 3:19:44 PM P:\2013\1000.01-B-5411-TrafficControl\Tep\B5411.TC_TMP_PSH_2.dgn

<p>WETHERILL ENGINEERING 559 Jones Franklin Rd, Suite 164 Raleigh, N.C. 27606 License No. F-0377 Bus: 919 851 8077 Fax: 919 851 8107</p> <p>TRANSPORTATION PLANNING/DESIGN - BRIDGE/STRUCTURE DESIGN CIVIL/SITE DESIGN - GIS/GPS - CONSTRUCTION OBSERVATION</p>	<p>APPROVED: <i>Greg S. Purvis</i> DATE: 6/9/14</p> <table border="0"> <tr> <td style="text-align: center;"> </td> <td style="text-align: center;"> </td> </tr> </table>			<h1>SIGN DESIGN DETAIL</h1>

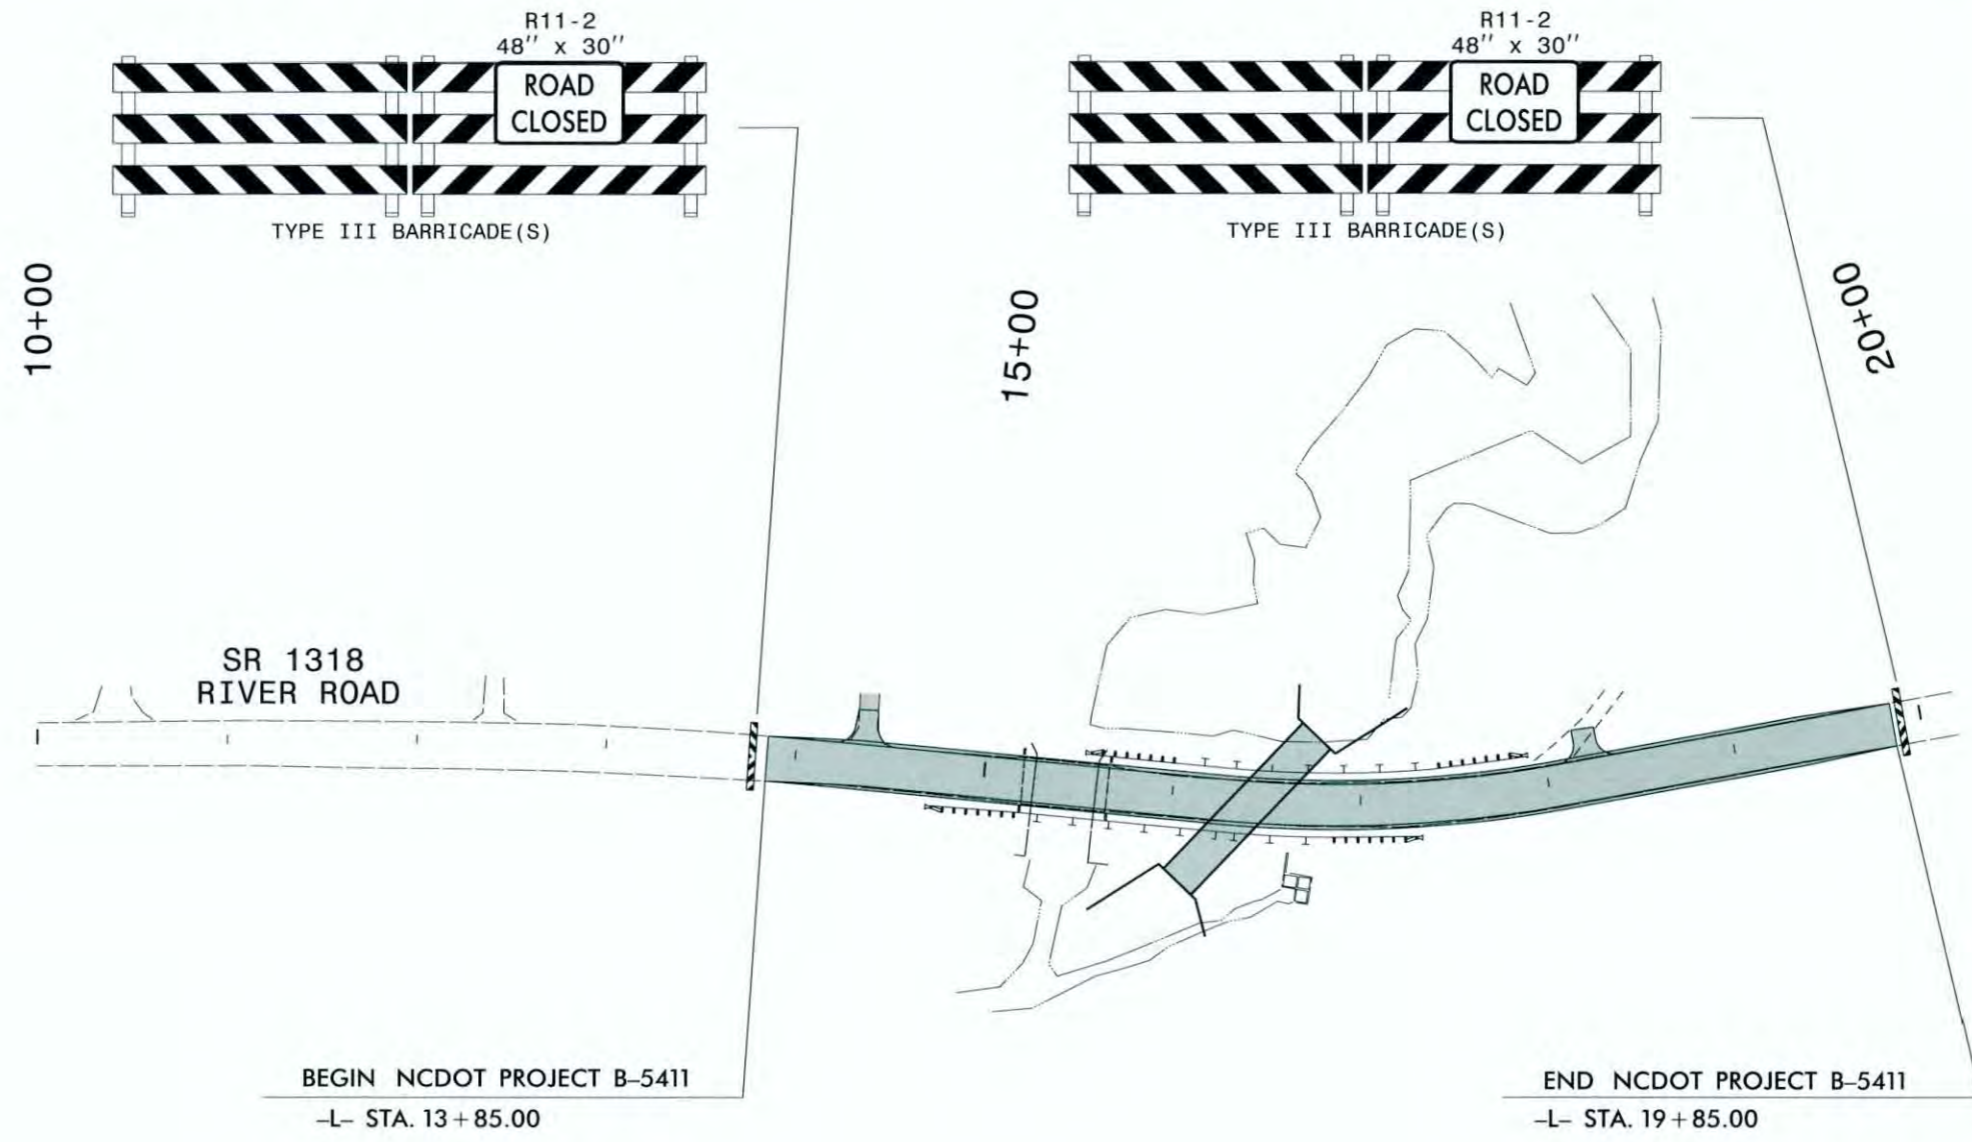

PHASING

- STEP 1. INSTALL AND COVER OFF-SITE DETOUR AND TRAILBLAZE SIGNING ACCORDING TO TMP-4 AND ROADWAY STANDARD DRAWINGS NO. 1101.03, SHEET 1 OF 9.
- STEP 2. PLACE TYPE III BARRICADES TO CLOSE RIVER ROAD TO TRAFFIC. UNCOVER ROAD CLOSURE AND TRAILBLAZE SIGNING AS SHOWN ON TMP-4.
- STEP 3. REMOVE EXISTING STRUCTURE AND CONSTRUCT PROPOSED -L- STRUCTURE AND APPROACHES ACCORDING TO THE CONSTRUCTION PLANS.
- STEP 4. PLACE FINAL PAVEMENT MARKINGS AND MARKERS ON -L- ROADWAY ACCORDING TO THE PAVEMENT MARKING PLANS.
- STEP 5. REMOVE TYPE III BARRICADES AND REOPEN RIVER ROAD TO TRAFFIC. REMOVE ROAD CLOSURE SIGNS AND TRAILBLAZE SIGNS.

SEE TMP-4 FOR OFF-SITE DETOUR ROUTE AND TEMPORARY SIGNING.
SEE PAVEMENT MARKING PLANS FOR MARKING AND MARKER TYPES.


6/9/2014
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TRANSPORTATION PLANNING/DESIGN - BRIDGE/STRUCTURE DESIGN
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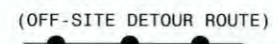
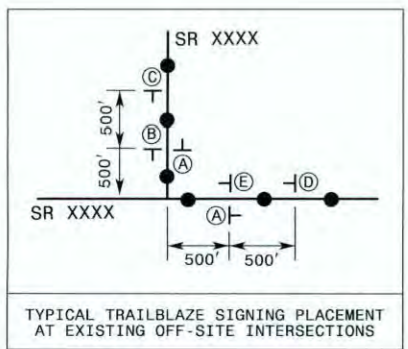
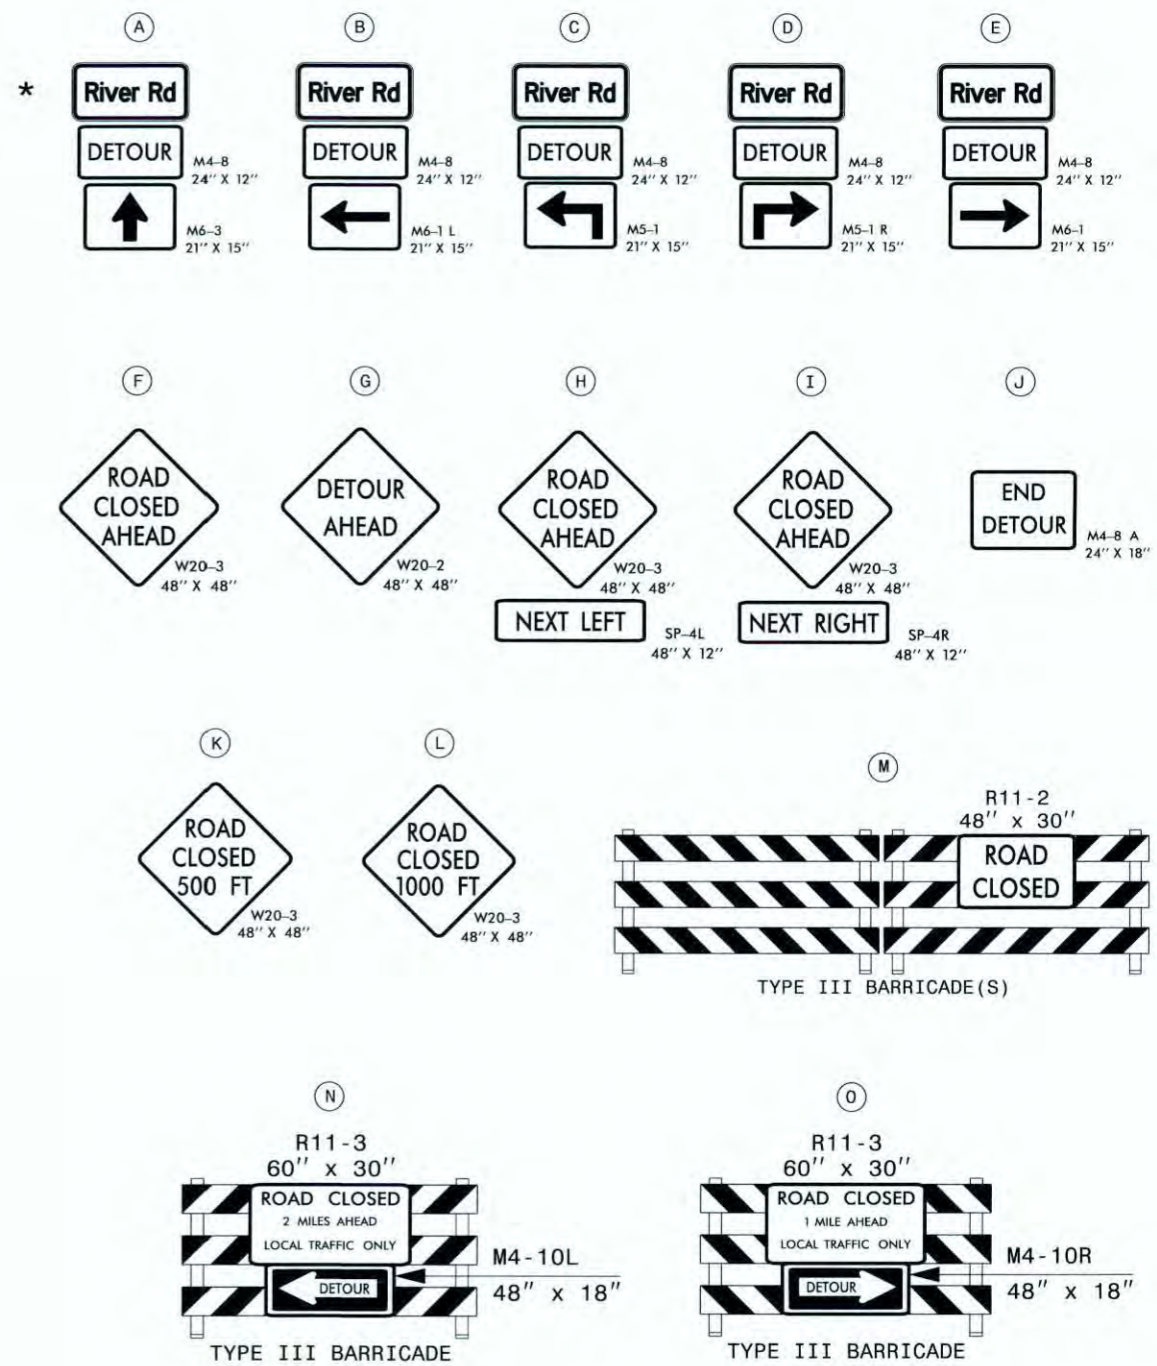
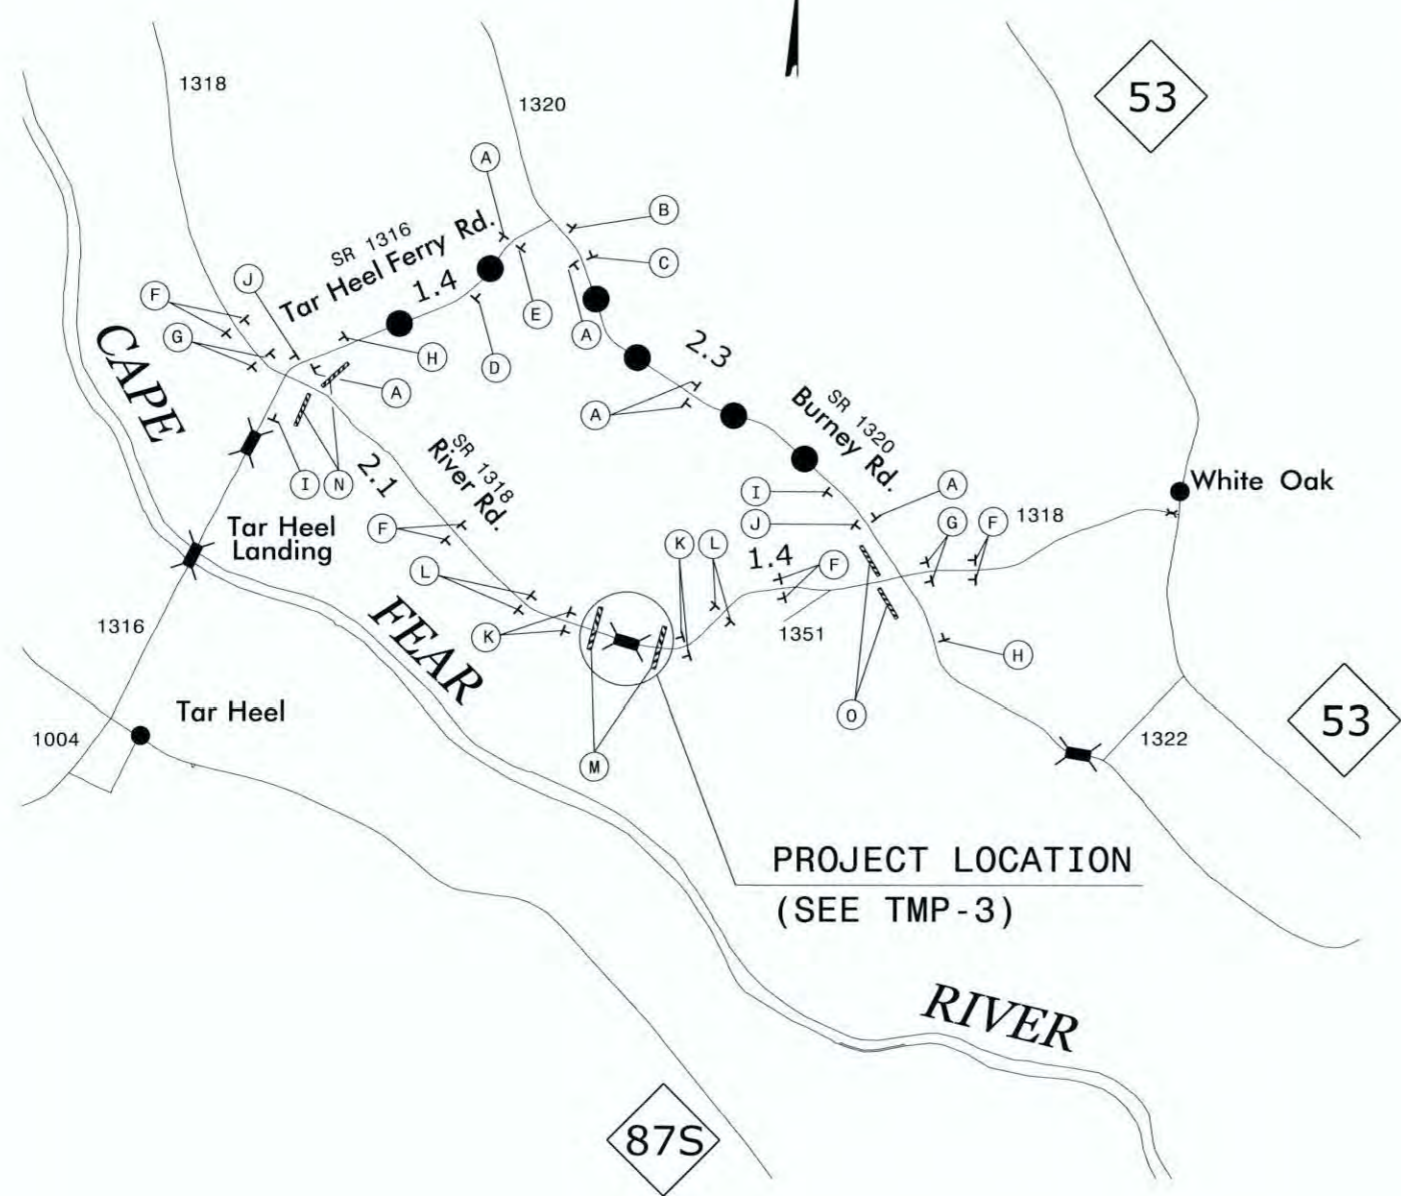
APPROVED: *Greg S. Purvis* DATE: 6/9/14

SEAL

TEMPORARY TRAFFIC CONTROL DETAIL AND PHASING

TEMPORARY DETOUR SIGNING AND TRAFFIC CONTROL DEVICES



* SEE TMP-2 FOR RIVER ROAD DETOUR SIGN DESIGN.
 REFER TO ROADWAY STANDARD DRAWING 1101.03, SHEET 1 OF 9, FOR ROAD CLOSURE SIGN SPACING REQUIREMENTS.

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TRANSPORTATION PLANNING/DESIGN - BRIDGE/STRUCTURE DESIGN
 CIVIL/SITE DESIGN - GIS/GPS - CONSTRUCTION OBSERVATION

APPROVED: DATE: 6/9/14

SEAL:

DIVISION OF HIGHWAYS
 STATE OF NORTH CAROLINA
 DEPARTMENT OF TRANSPORTATION
 WORK ZONE TRAFFIC CONTROL

RIVER ROAD OFF-SITE DETOUR

TIP NO. B-5411	SHEET NO. PMP-1
APPROVED: <i>Greg Purvis</i>	
DATE: 6/9/14	
SEAL	

**STATE OF NORTH CAROLINA
DEPARTMENT OF TRANSPORTATION**

**PAVEMENT MARKING PLAN
BLADEN COUNTY**

T.I.P.: B-5411

INDEX

SHEET NO.	DESCRIPTION
PMP-1	PAVEMENT MARKING PLAN COVER SHEET
PMP-2	PAVEMENT MARKING DETAIL AND MARKING SCHEDULE

ROADWAY STANDARD DRAWING

THE FOLLOWING ROADWAY STANDARDS AS APPEAR IN "ROADWAY STANDARD DRAWINGS" - PROJECT SERVICES UNIT - N.C. DEPARTMENT OF TRANSPORTATION - RALEIGH, N.C., DATED JANUARY 2012 ARE APPLICABLE TO THIS PROJECT AND BY REFERENCE HEREBY ARE CONSIDERED A PART OF THESE PLANS:

STD. NO.	TITLE
1205.01	PAVEMENT MARKINGS - LINE TYPES AND OFFSETS
1205.02	PAVEMENT MARKINGS - 2 LANE AND MULTILANE ROADWAYS
1250.01	PAVEMENT MARKER SPACING
1251.01	RAISED PAVEMENT MARKERS - TEMPORARY AND PERMANENT
1261.01	GUARDRAIL AND BARRIER DELINEATOR SPACING
1261.02	GUARDRAIL AND BARRIER DELINEATOR TYPES
1262.01	GUARDRAIL END DELINEATION

GENERAL NOTES

THE FOLLOWING GENERAL NOTES APPLY AT ALL TIMES FOR THE DURATION OF THE CONSTRUCTION PROJECT, EXCEPT WHEN OTHERWISE NOTED IN THE PLAN, OR DIRECTED BY THE ENGINEER.

A) INSTALL PAVEMENT MARKINGS AND PAVEMENT MARKERS ON THE FINAL SURFACE AS FOLLOWS:

ROAD NAME	MARKING	MARKER
1. SR 1318 (RIVER RD.) (-L- ROADWAY)	THERMOPLASTIC	RAISED REFLECTIVE

B) TIE PROPOSED PAVEMENT MARKING LINES TO EXISTING PAVEMENT MARKING LINES.

C) REMOVE/REPLACE ANY CONFLICTING/DAMAGED PAVEMENT MARKINGS AND MARKERS.

D) PASSING ZONES WILL BE DETERMINED IN THE FIELD AND MUST BE APPROVED BY THE ENGINEER.

E) MARKERS SHALL BE INSTALLED ACCORDING TO THE NCDOT ROADWAY STANDARD DRAWING 1250.01.

CONTRACT:

PLAN REVIEWED BY: N.C.D.O.T. SIGNING AND DELINEATION UNIT

AYMAN ALQUDWAH, P.E. SIGNING & DELINEATION STANDARDS ENGINEER

_____ SIGNING & DELINEATION PROJECT DESIGN ENGINEER





PLAN PREPARED BY: WETHERILL ENGINEERING, INC.

GREG PURVIS, P.E. ROADWAY PROJECT ENGINEER

CHARLES MULLEN TRAFFIC CONTROL & PAVEMENT MARKING SPECIALIST



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PAVEMENT MARKING SCHEDULE

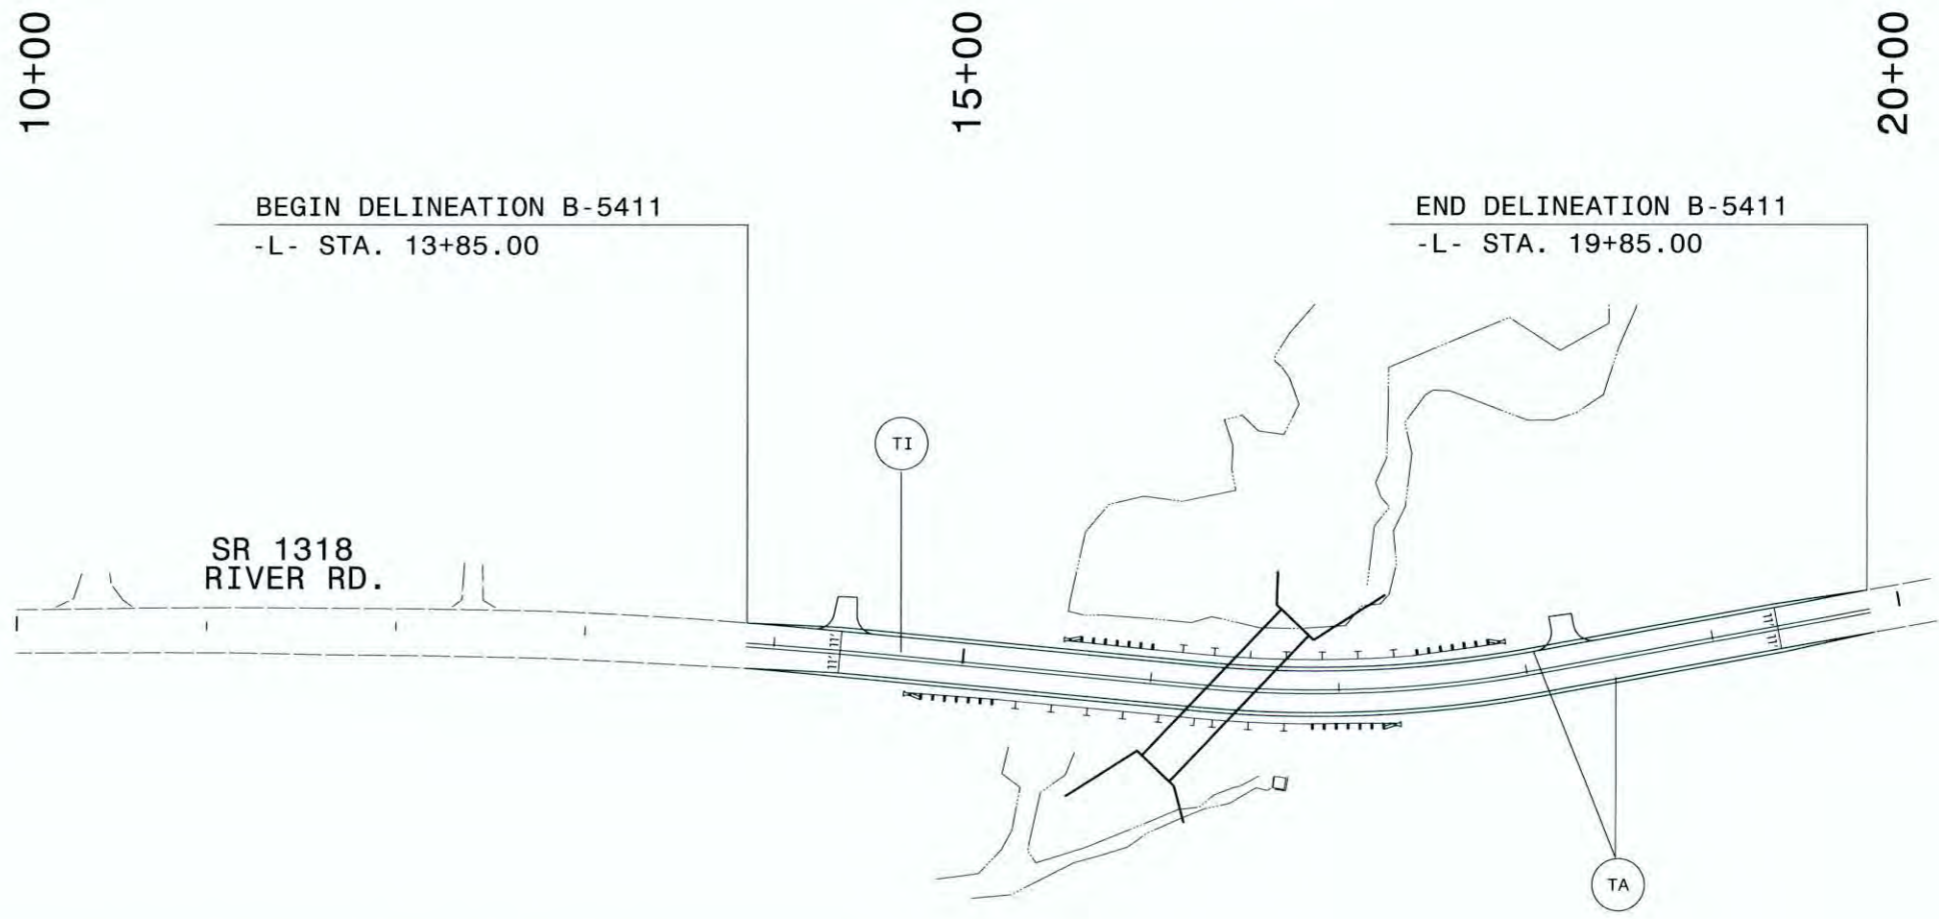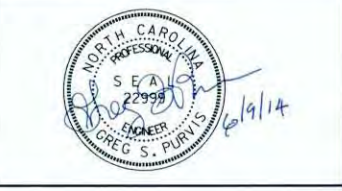SYMBOL	DESCRIPTION	PAY ITEM
FINAL PAVEMENT MARKINGS		
		THERMOPLASTIC (4", 90 MILS)
TA	WHITE EDGELINE	
		THERMOPLASTIC (4", 120 MILS)
TI	YELLOW DOUBLE CENTER	
MARKERS		
PERMANENT RAISED PAVEMENT MARKERS		
MA	YELLOW & YELLOW	

PAVEMENT MARKERS SHALL BE INSTALLED ACCORDING TO ROADWAY STANDARD DRAWING 1250.01.


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559 Jones Franklin Rd. Suite 164
 Raleigh, N.C. 27606
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TRANSPORTATION PLANNING/DESIGN - BRIDGE/STRUCTURE DESIGN
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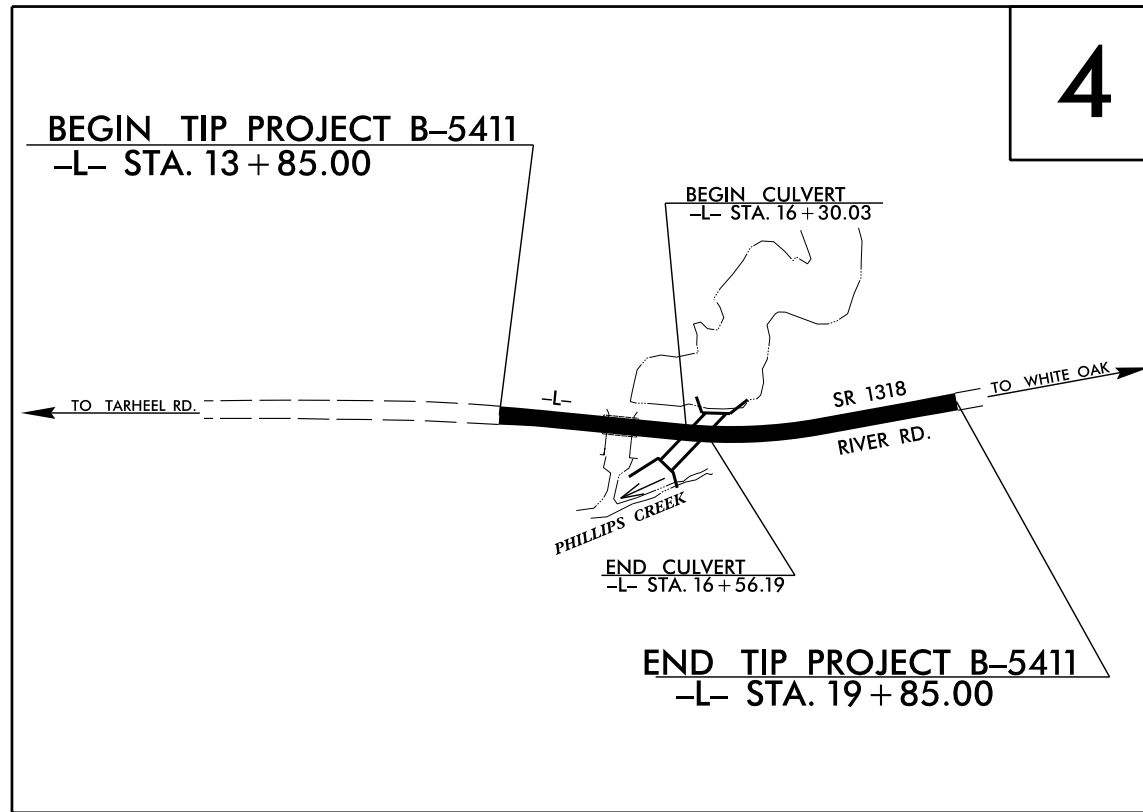
PAVEMENT MARKING DETAIL AND MARKING SCHEDULE

TIP PROJECT: B-5411



STATE OF NORTH CAROLINA
DIVISION OF HIGHWAYS
PLAN FOR PROPOSED
HIGHWAY EROSION CONTROL
BLADEN COUNTY

LOCATION: BRIDGE NO. 124 OVER PHILLIPS CREEK ON SR 1318 (RIVER RD.)
TYPE OF WORK: GRADING, DRAINAGE, PAVING & CULVERT

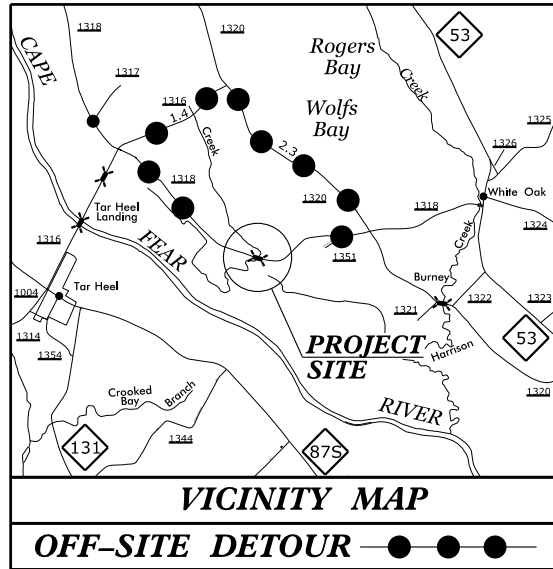

STATE	STATE PROJECT REFERENCE NO.	SHEET NO.	TOTAL SHEETS
N.C.	45427.1.1	EC-1	
STATE PROJ. NO.	F.A. PROJ. NO.	DESCRIPTION	

EROSION AND SEDIMENT CONTROL MEASURES


Std. #	Description	Symbol
1630.03	Temporary Silt Ditch	no
1630.05	Temporary Diversion	— TD —
1605.01	Temporary Silt Fence	— III — III — III —
1606.01	Special Sediment Control Fence	— X — X — X —
1622.01	Temporary Berms and Slope Drains	— T —
1630.02	Silt Basin Type B	▨
1633.01	Temporary Rock Silt Check Type-A	▩
	Temporary Rock Silt Check Type-A with Matting and Polyacrylamide (PAM)	▩
1633.02	Temporary Rock Silt Check Type-B	▩
	Wattle / Coir Fiber Wattle	— W —
	Wattle / Coir Fiber Wattle with Polyacrylamide (PAM)	— W —
1634.01	Temporary Rock Sediment Dam Type-A	▩
1634.02	Temporary Rock Sediment Dam Type-B	▩
1635.01	Rock Pipe Inlet Sediment Trap Type-A	⊓
1635.02	Rock Pipe Inlet Sediment Trap Type-B	⊓
1630.04	Stilling Basin	▭
1630.06	Special Stilling Basin	▭
	Rock Inlet Sediment Trap:	
1632.01	Type A	A
1632.02	Type B	B
1632.03	Type C	C
	Skimmer Basin	▭
	Tiered Skimmer Basin	▭
	Infiltration Basin	▭

THIS PROJECT CONTAINS
EROSION CONTROL PLANS
FOR CLEARING AND
GRUBBING PHASE OF
CONSTRUCTION.

ANNE D, GAMBER, PE, CFM
LEVEL IIIA NAME

3022
LEVEL IIIA CERTIFICATION NO.

GRAPHIC SCALE

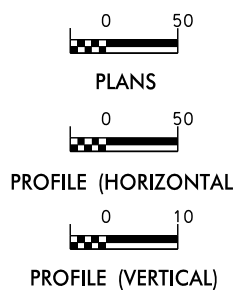

ROADSIDE ENVIRONMENTAL UNIT
DIVISION OF HIGHWAYS
STATE OF NORTH CAROLINA

THESE EROSION AND SEDIMENT CONTROL PLANS COMPLY
WITH THE REGULATIONS SET FORTH BY THE
NCG-010000 GENERAL CONSTRUCTION PERMIT EFFECTIVE AUGUST 3, 2011
ISSUED BY THE NORTH CAROLINA DEPARTMENT OF ENVIRONMENT AND
NATURAL RESOURCES DIVISION OF WATER QUALITY.

WETHERILL ENGINEERING
Prepared for the North Carolina Department
of Transportation in the Office of:
559 JONES BRANCH ROAD
SUITE 164
RALEIGH, N.C. 27605
License No. EC2377
Bus: 919 851 8077
Fax: 919 851 8107


2012 STANDARD SPECIFICATIONS	
RIGHT OF WAY DATE:	EDWARD G. WETHERILL, PE PROJECT ENGINEER
LETTING DATE:	GREG S. PURVIS, PE PROJECT DESIGN ENGINEER

Roadway Standard Drawings


The following roadway english standards as appear in "Roadway Standard Drawings"- Roadway Design Unit - N. C. Department of Transportation - Raleigh, N. C., dated January 2012 and the latest revision thereto are applicable to this project and by reference hereby are considered a part of these plans.

1604.01 Railroad Erosion Control Detail	1632.01 Rock Inlet Sediment Trap Type A
1605.01 Temporary Silt Fence	1632.02 Rock Inlet Sediment Trap Type B
1606.01 Special Sediment Control Fence	1632.03 Rock Inlet Sediment Trap Type C
1607.01 Gravel Construction Entrance	1633.01 Temporary Rock Silt Check Type A
1622.01 Temporary Berms and Slope Drains	1633.02 Temporary Rock Silt Check Type B
1630.01 Riser Basin	1634.01 Temporary Rock Sediment Dam Type A
1630.02 Silt Basin Type B	1634.02 Temporary Rock Sediment Dam Type B
1630.03 Temporary Silt Ditch	1635.01 Rock Pipe Inlet Sediment Trap Type A
1630.04 Stilling Basin	1635.02 Rock Pipe Inlet Sediment Trap Type B
1630.05 Temporary Diversion	1640.01 Coir Fiber Baffle
1630.06 Special Stilling Basin	1645.01 Temporary Stream Crossing
1631.01 Matting Installation	

SILT FENCE COIR FIBER WATTLE BREAK DETAIL

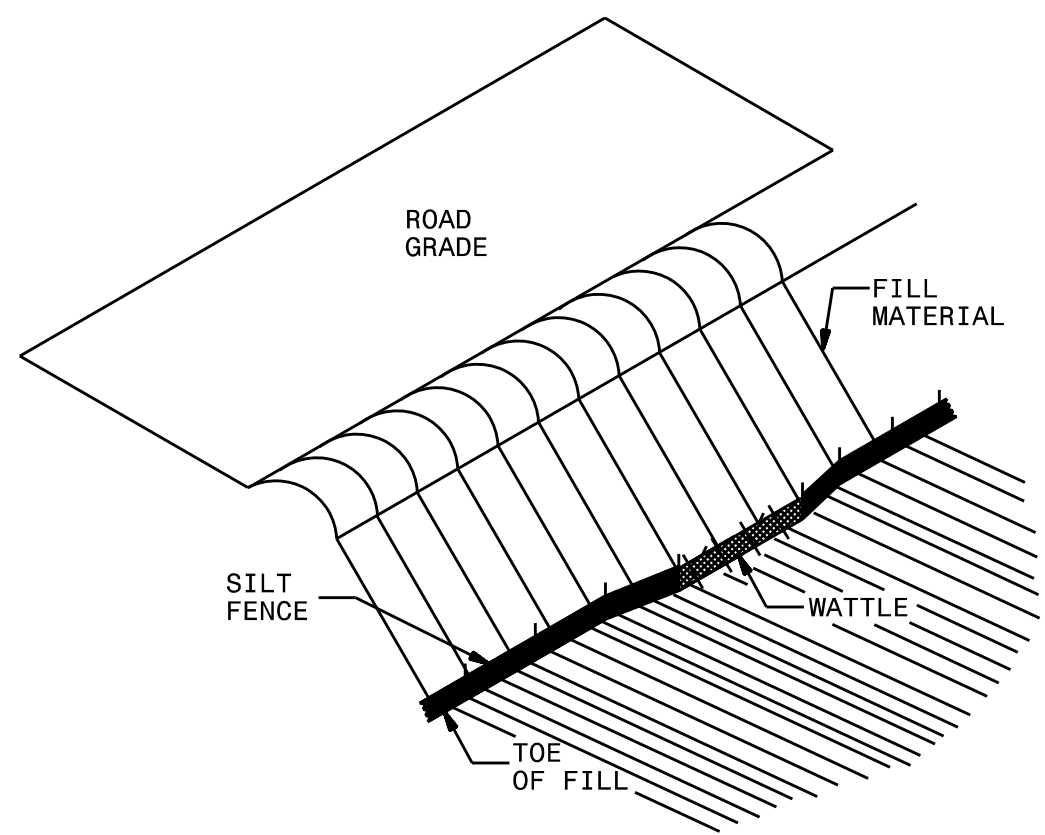

ISOMETRIC VIEW


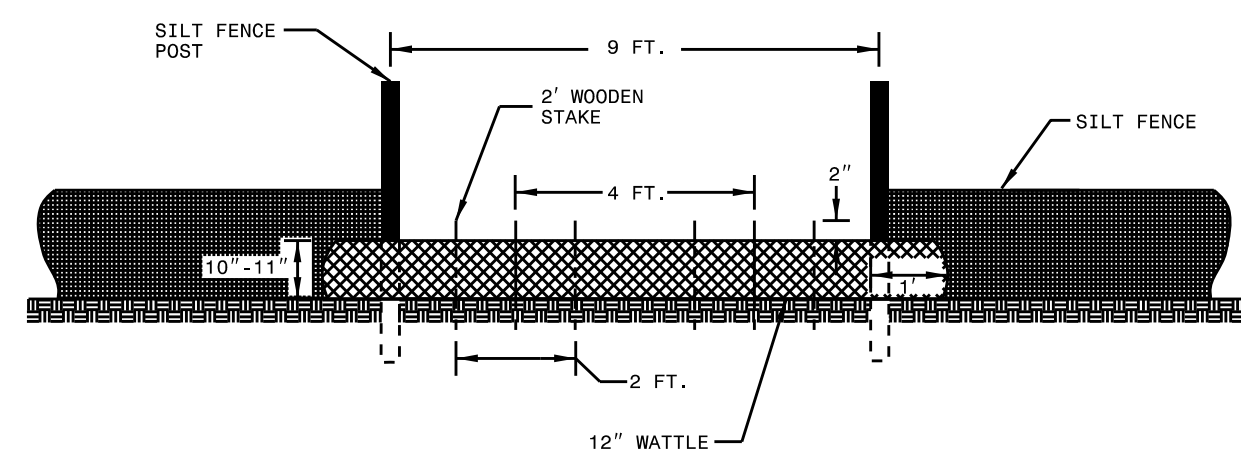


VIEW FROM SLOPE

NOTES:

- USE MINIMUM 12 IN. DIAMETER COIR FIBER (COCONUT FIBER) WATTLE AND LENGTH OF 10 FT.
- EXCAVATE A 1 TO 2 INCH TRENCH FOR WATTLE TO BE PLACED.
- DO NOT PLACE WATTLE ON TOE OF SLOPE.
- USE 2 FT. WOODEN STAKES WITH A 2 IN. BY 2 IN. NOMINAL CROSS SECTION.
- INSTALL A MINIMUM OF 2 UPSLOPE STAKES AND 4 DOWNSLOPE STAKES AT AN ANGLE TO WEDGE WATTLE TO GROUND.
- PROVIDE STAPLES MADE OF 0.125 IN. DIAMETER STEEL WIRE FORMED INTO A U SHAPE NOT LESS THAN 12" IN LENGTH.
- INSTALL STAPLES APPROXIMATELY EVERY 1 LINEAR FOOT ON BOTH SIDES OF WATTLE AND AT EACH END TO SECURE IT TO THE SOIL.
- WATTLE INSTALLATION CAN BE ON OUTSIDE OF THE SILT FENCE AS DIRECTED.
- INSTALL TEMPORARY SILT FENCE IN ACCORDANCE WITH SECTION 1605 OF THE STANDARD SPECIFICATIONS.

INSET A

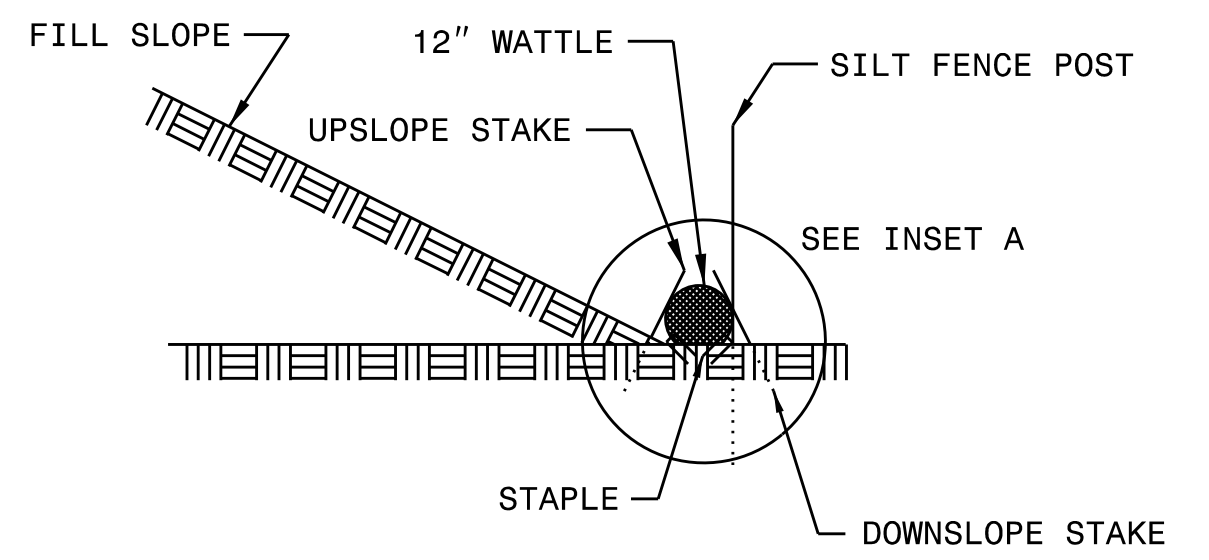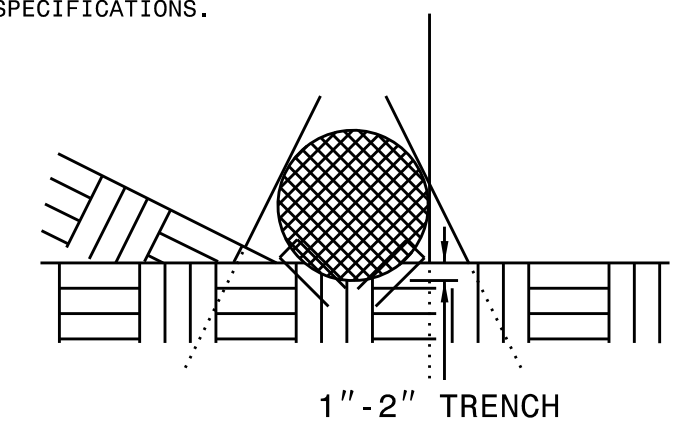


SIDE VIEW

DIVISION OF HIGHWAYS
STATE OF NORTH CAROLINA



SOIL STABILIZATION TIMEFRAMES

<i>SITE DESCRIPTION</i>	<i>STABILIZATION TIME</i>	<i>TIMEFRAME EXCEPTIONS</i>
PERIMETER DIKES, SWALES, DITCHES AND SLOPES	7 DAYS	NONE
HIGH QUALITY WATER (HQW) ZONES	7 DAYS	NONE
SLOPES STEEPER THAN 3:1	7 DAYS	IF SLOPES ARE 10' OR LESS IN LENGTH AND ARE NOT STEEPER THAN 2:1, 14 DAYS ARE ALLOWED.
SLOPES 3:1 OR FLATTER	14 DAYS	7 DAYS FOR SLOPES GREATER THAN 50' IN LENGTH.
ALL OTHER AREAS WITH SLOPES FLATTER THAN 4:1	14 DAYS	NONE, EXCEPT FOR PERIMETERS AND HQW ZONES.

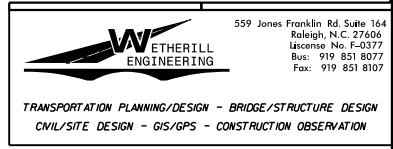

PARCEL INDEX	
PARCEL NO.	PROPERTY OWNER NAME
1	ROCKING A RANCH, INC
2	ROCKING A RANCH, INC
3	ASTRAKEL INTERNATIONAL, LTD

NOTE: PERIMETER EROSION CONTROL MEASURES SHALL BE INSTALLED DURING CLEARING AND GRUBBING PHASE.

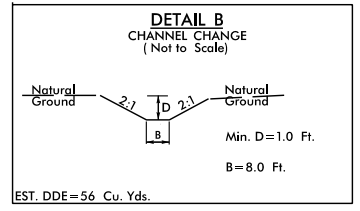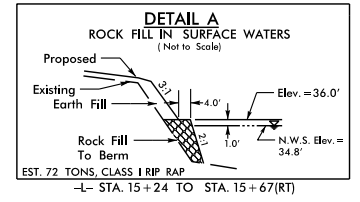


DATUM DESCRIPTION
 THE LOCALIZED COORDINATE SYSTEM DEVELOPED FOR THIS PROJECT IS BASED ON THE STATE PLANE COORDINATES ESTABLISHED BY NCDOT FOR MONUMENT "B5411-2" WITH NAD 83/NA 2011 STATE PLANE GRID COORDINATES OF NORTHING: 360071.887(ft) EASTING: 2074424.528(ft) ELEVATION: 50.87(ft)
 THE AVERAGE COMBINED GRID FACTOR USED ON THIS PROJECT (GROUND TO GRID) IS: 0.99991521
 THE N.C. LAMBERT GRID BEARING AND LOCALIZED HORIZONTAL DISTANCE FROM "B5411-2" TO -L- STATION 10+00.00 IS N 85° 9' 53" W 78.55'
 ALL LINEAR DIMENSIONS ARE LOCALIZED HORIZONTAL DISTANCES VERTICAL DATUM USED IS NAVD 88

PIPE ARCH HYDRAULIC DATA

DESIGN DISCHARGE	= 800	CFS
DESIGN FREQUENCY	= 25	YRS
DESIGN HW ELEVATION	= 43.9	FT
BASE DISCHARGE	= 1,200	CFS
BASE FREQUENCY	= 100	YRS
BASE HW ELEVATION	= 45.93	FT
OVERTOPPING DISCHARGE	= > 1,700	CFS
OVERTOPPING FREQUENCY	= 500+	YRS
OVERTOPPING ELEVATION	= 53.0	FT

DATE OF SURVEY	= 11/13/12
W.S. ELEVATION AT DATE OF SURVEY	= 40.7 FT

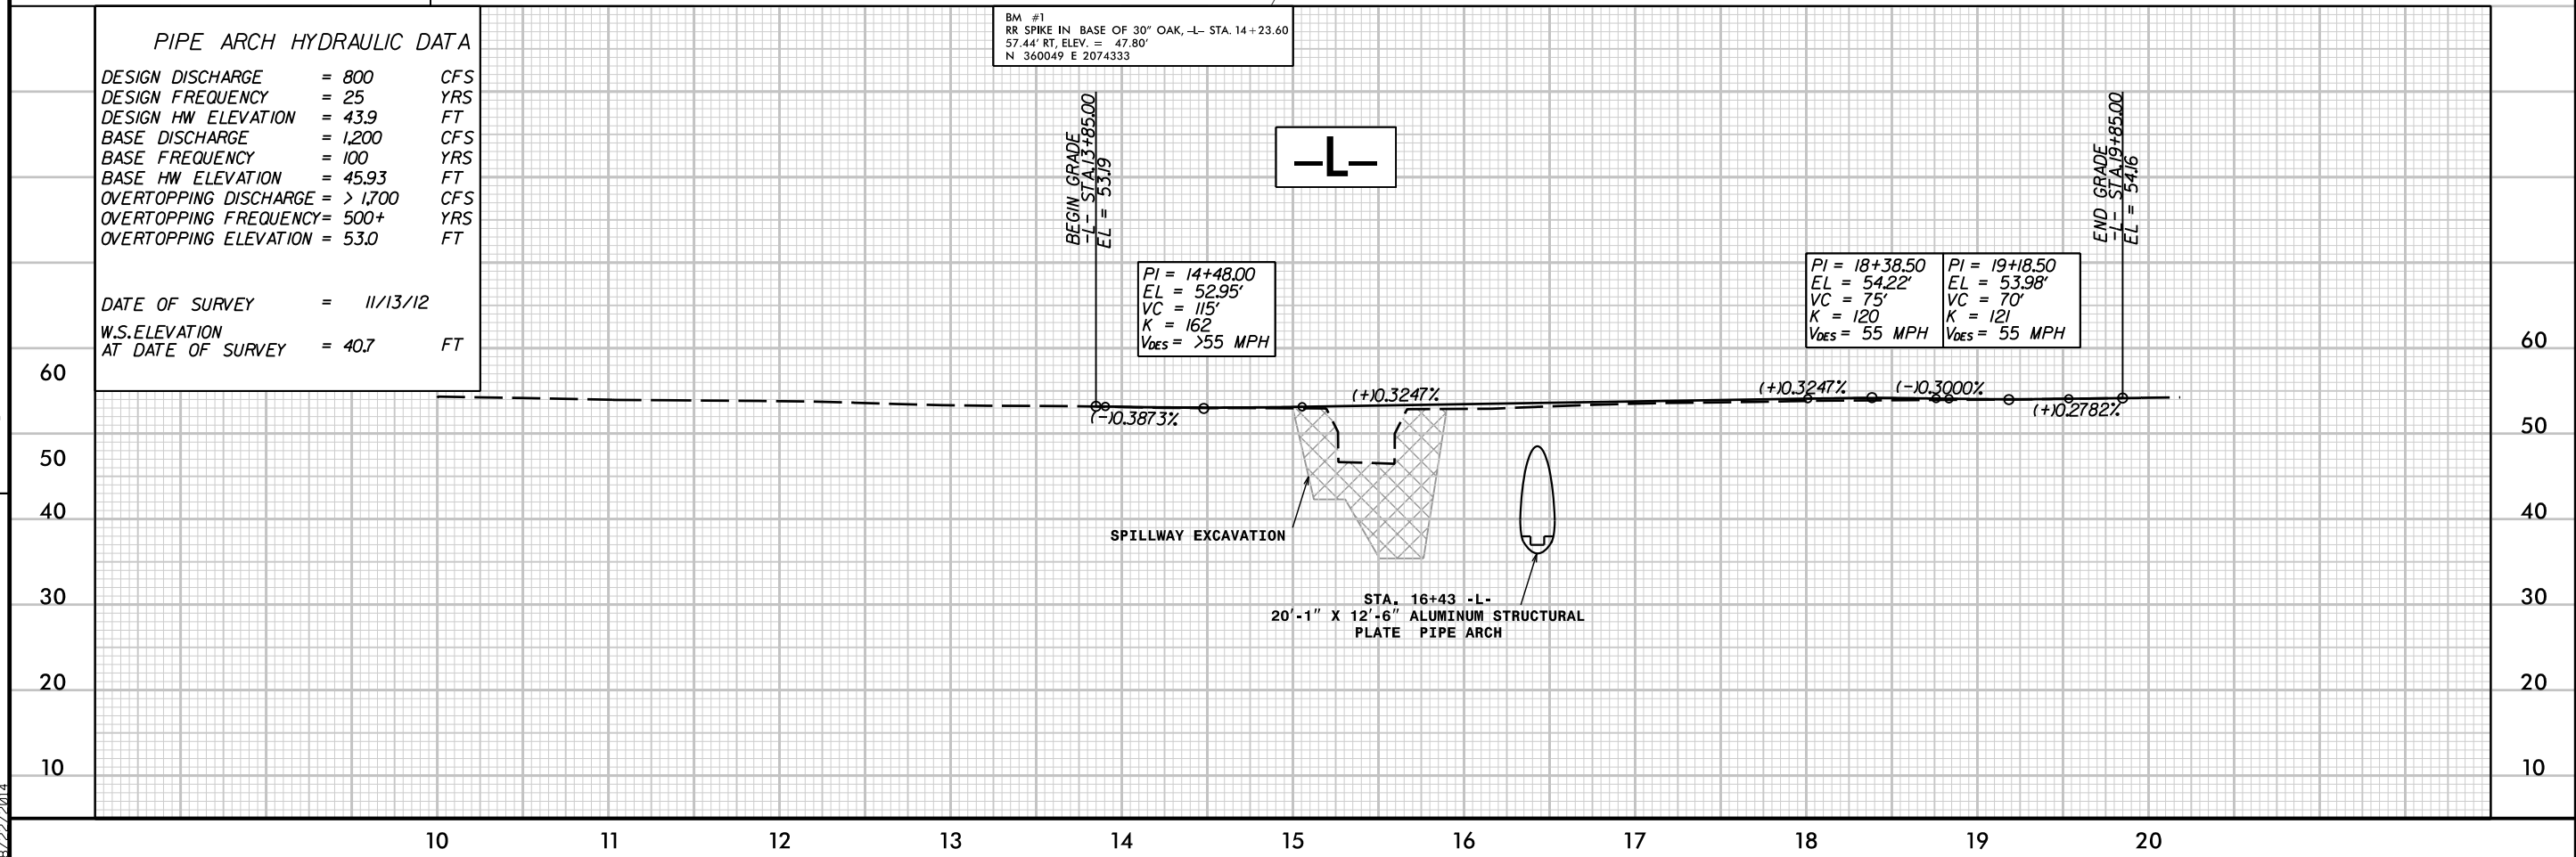


CLEARING AND GRUBBING EROSION CONTROL FOR CONSTRUCTION SHEET 4




NOTE: PLACE TEMPORARY ROCK SEDIMENT DAMS TYPE - B AND TEMPORARY ROCK SILT CHECKS TYPE - A AT DRAINAGE OUTLETS.

REVISIONS


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 11/22/12

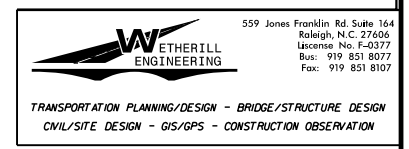

PARCEL INDEX	
PARCEL NO.	PROPERTY OWNER NAME
1	ROCKING A RANCH, INC
2	ROCKING A RANCH, INC
3	ASTRAKEL INTERNATIONAL,LTD

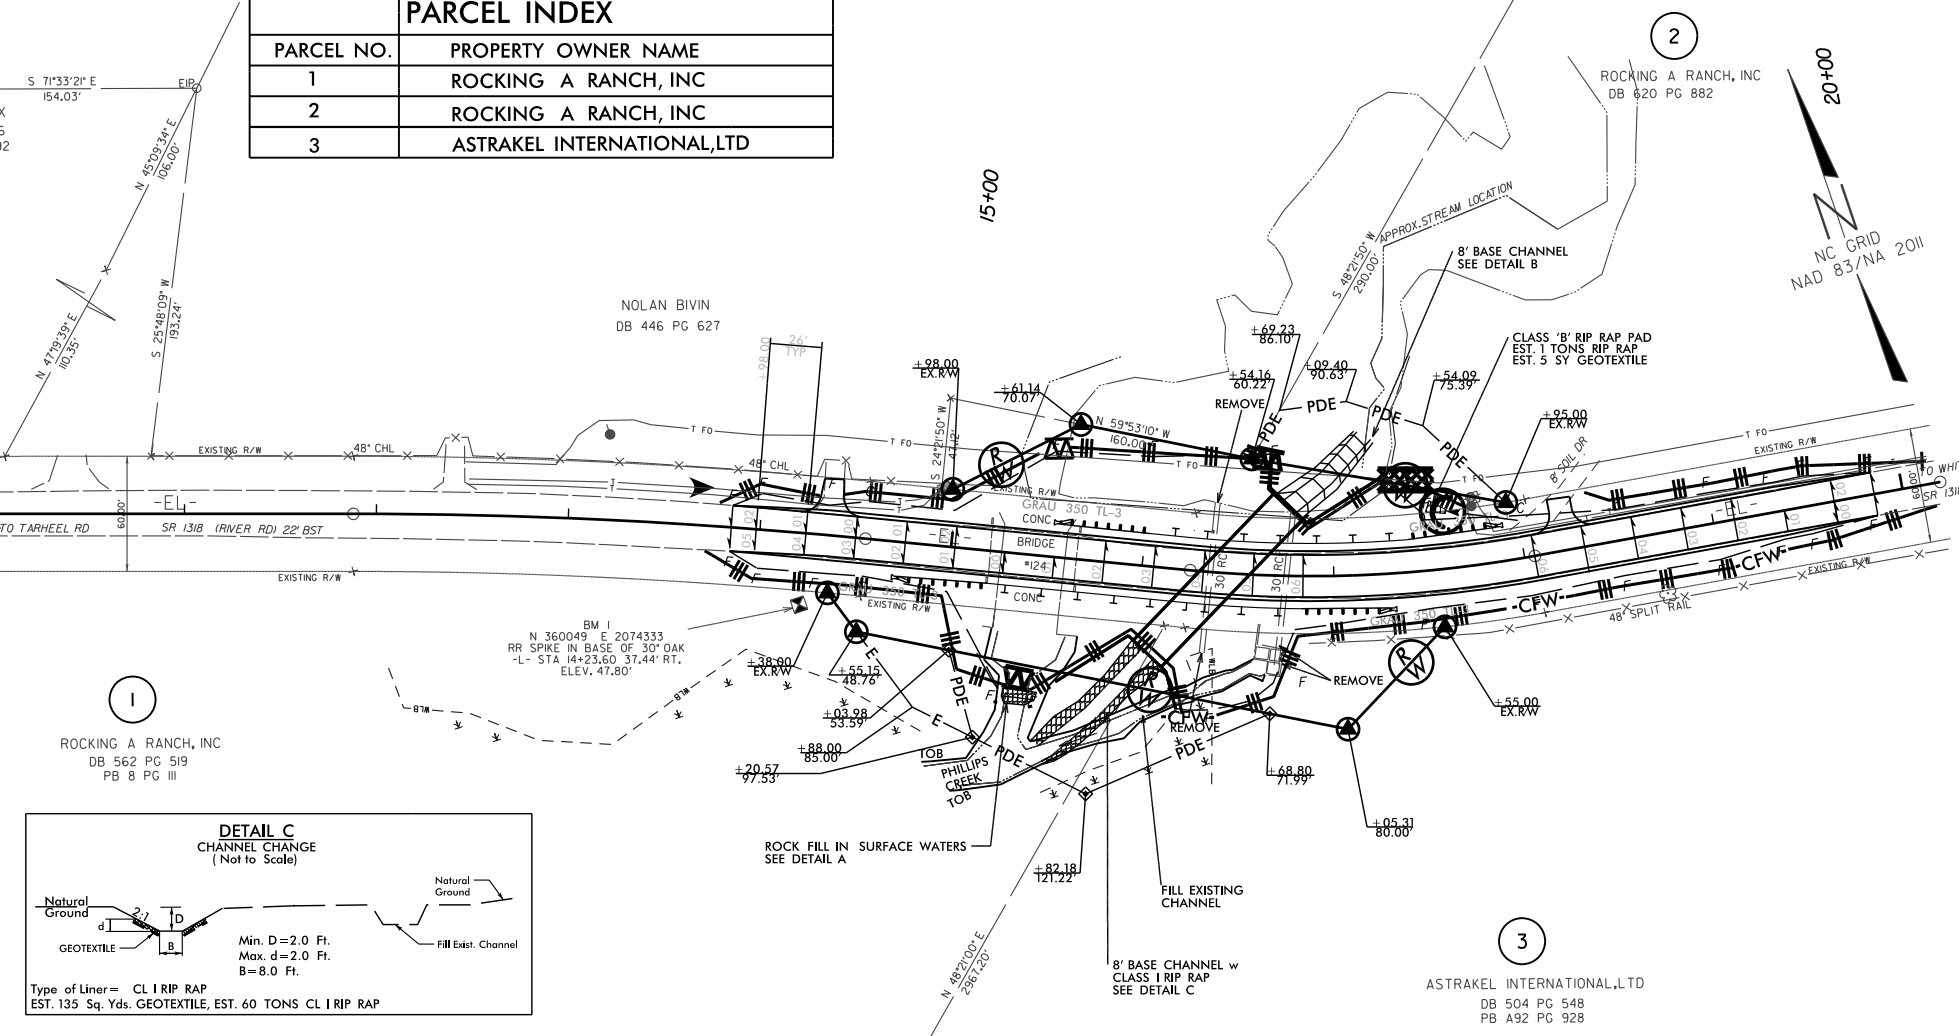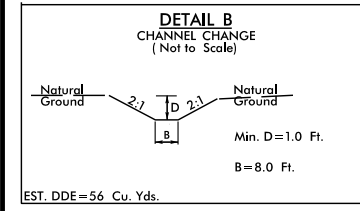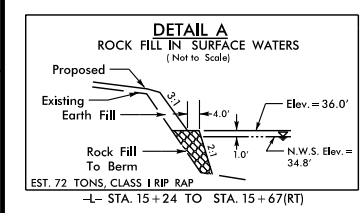

DATUM DESCRIPTION
 THE LOCALIZED COORDINATE SYSTEM DEVELOPED FOR THIS PROJECT IS BASED ON THE STATE PLANE COORDINATES ESTABLISHED BY NCDOT FOR MONUMENT "B5411-2" WITH NAD 83/NA 2011 STATE PLANE GRID COORDINATES OF NORTHING: 360071.887(ft) EASTING: 2074424.528(ft) ELEVATION: 50.871(ft)
 THE AVERAGE COMBINED GRID FACTOR USED ON THIS PROJECT (GROUND TO GRID) IS: 0.99991521
 THE N.C. LAMBERT GRID BEARING AND LOCALIZED HORIZONTAL GROUND DISTANCE FROM "B5411-2" TO -L- STATION 10+00.00 IS N 85° 9' 53" W 78.55'
 ALL LINEAR DIMENSIONS ARE LOCALIZED HORIZONTAL DISTANCES VERTICAL DATUM USED IS NAVD 88

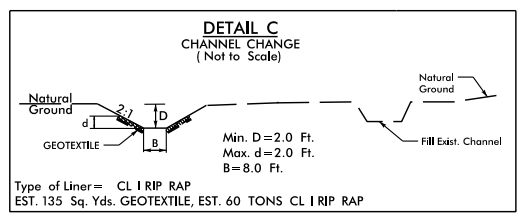


PIPE ARCH HYDRAULIC DATA

DESIGN DISCHARGE	= 800	CFS
DESIGN FREQUENCY	= 25	YRS
DESIGN HW ELEVATION	= 43.9	FT
BASE DISCHARGE	= 1,200	CFS
BASE FREQUENCY	= 100	YRS
BASE HW ELEVATION	= 45.93	FT
OVERTOPPING DISCHARGE	= > 1,700	CFS
OVERTOPPING FREQUENCY	= 500+	YRS
OVERTOPPING ELEVATION	= 53.0	FT

DATE OF SURVEY = 11/13/12
 W.S. ELEVATION AT DATE OF SURVEY = 40.7 FT

BM #1
 RR SPIKE IN BASE OF 30" OAK, -L- STA. 14+23.60
 57.44' RT. ELEV. = 47.80'
 N 360049 E 2074333

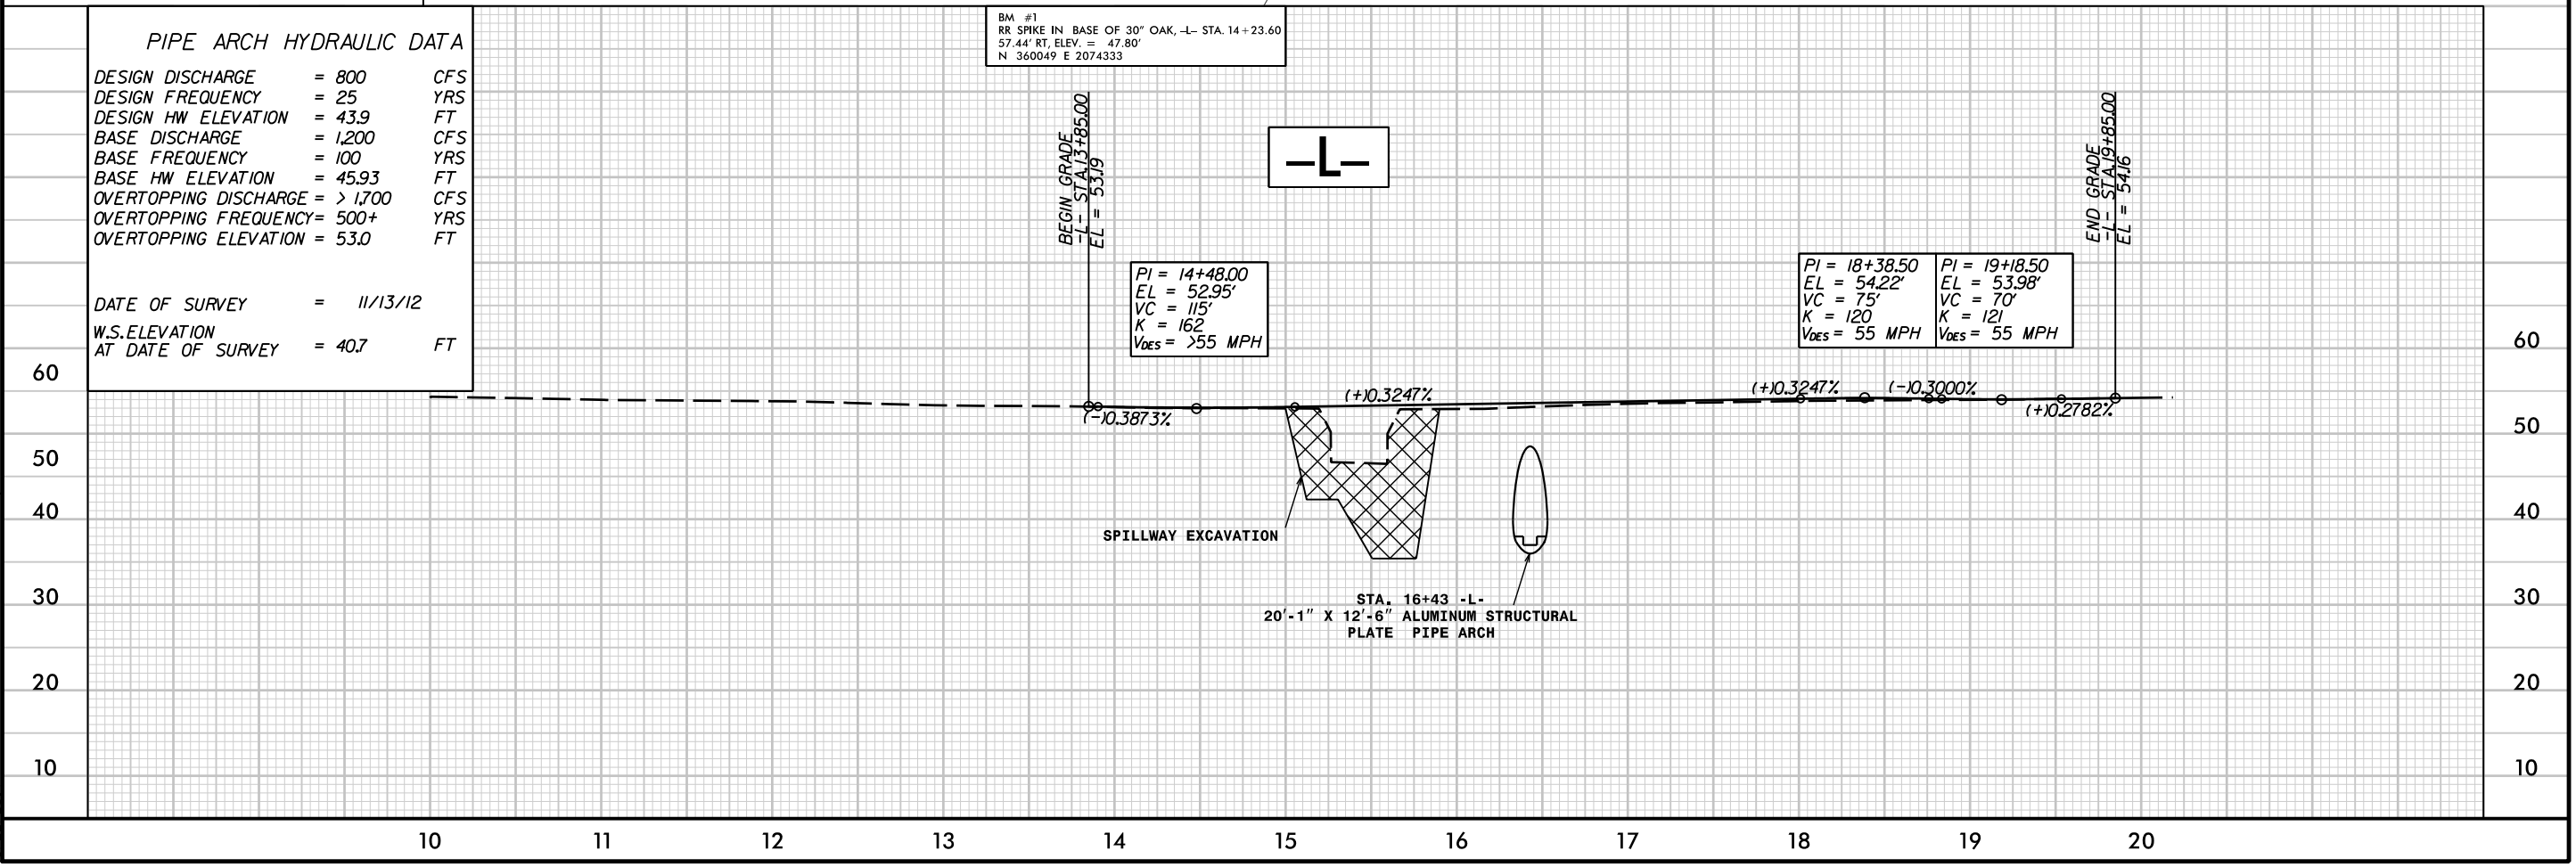

REVISIONS

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 8/17/99



CONSTRUCTION SEQUENCE

PHASE 1

1. INSTALL IMPERVIOUS DIKES 1 AND 2.
2. INSTALL STILLING BASIN(S) (MIN VOL. 120 cy) USING BERMS.
3. DEWATER AND PUMP AROUND AS REQUIRED FOR CONSTRUCTION USING EXISTING BRIDGE FOR LOW FLOW.
4. PERFORM REQUIRED EXCAVATION FOR CULVERT INCLUDING REMOVAL OF BOTH 30" RCP AND CONCRETE BOXES.
5. CONSTRUCT PROPOSED CULVERT, WING WALLS AND DOWNSTREAM CHANNEL CHANGE (SEE DETAIL C).
6. REMOVE IMPERVIOUS DIKES 1 AND 2.

PHASE 2

7. INSTALL IMPERVIOUS DIKE 3.
8. INSTALL STILLING BASIN(S) (MIN VOL. 93 cy) USING BERMS.
9. DEWATER AND PUMP AROUND AS REQUIRED FOR CONSTRUCTION USING NEWLY CONSTRUCTED CULVERT FOR LOW FLOW.
10. EXCAVATE EXISTING BRIDGE AND UNSUITABLE MATERIAL.
11. BACKFILL AND CONSTRUCT PROPOSED ROADWAY

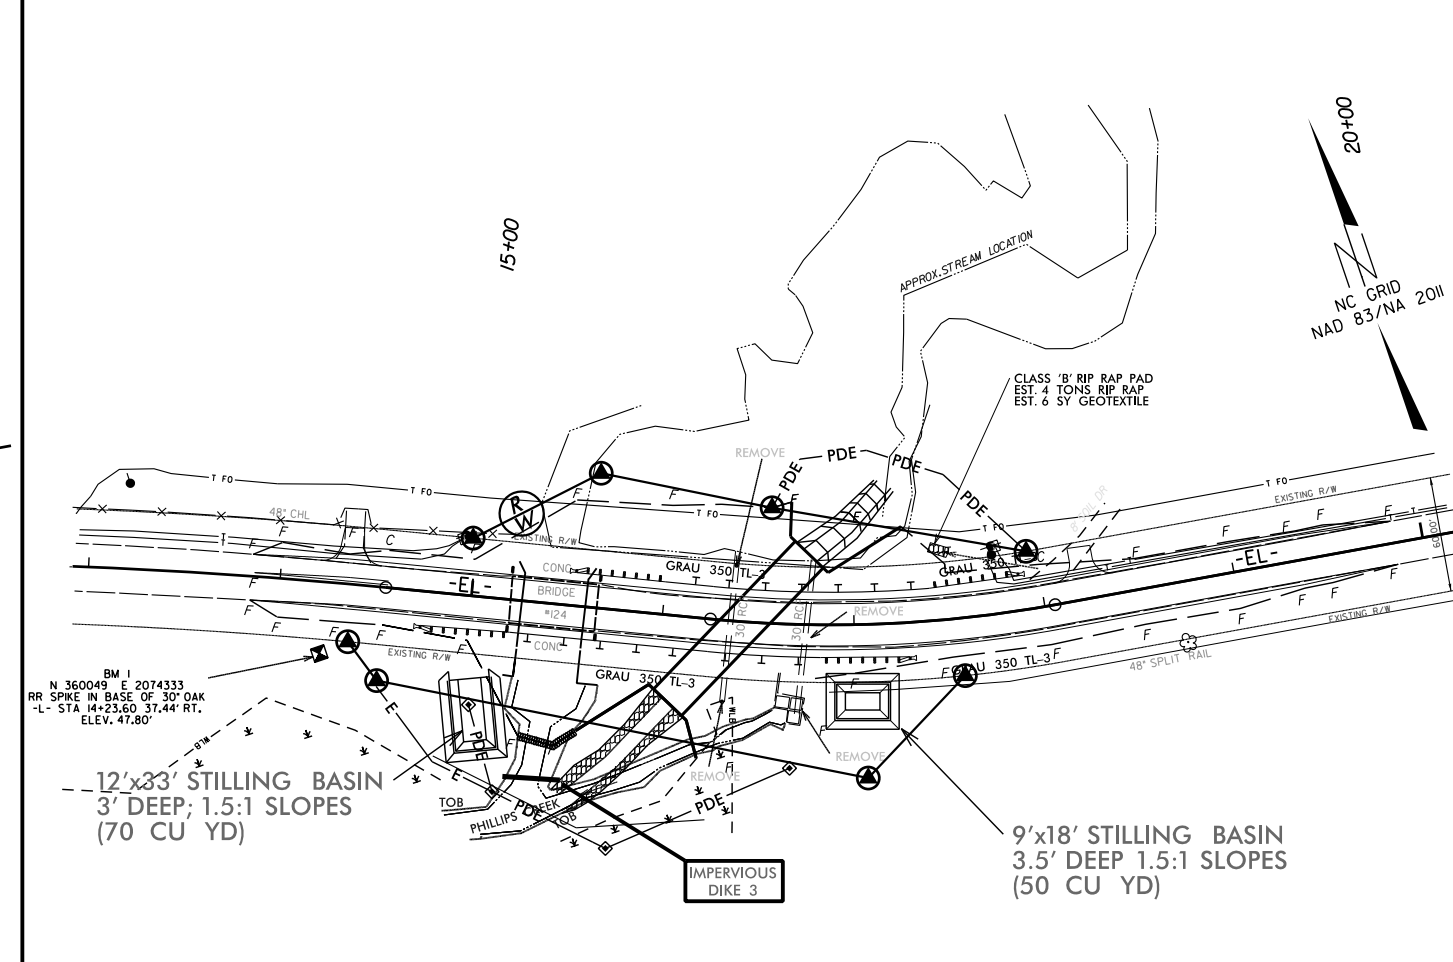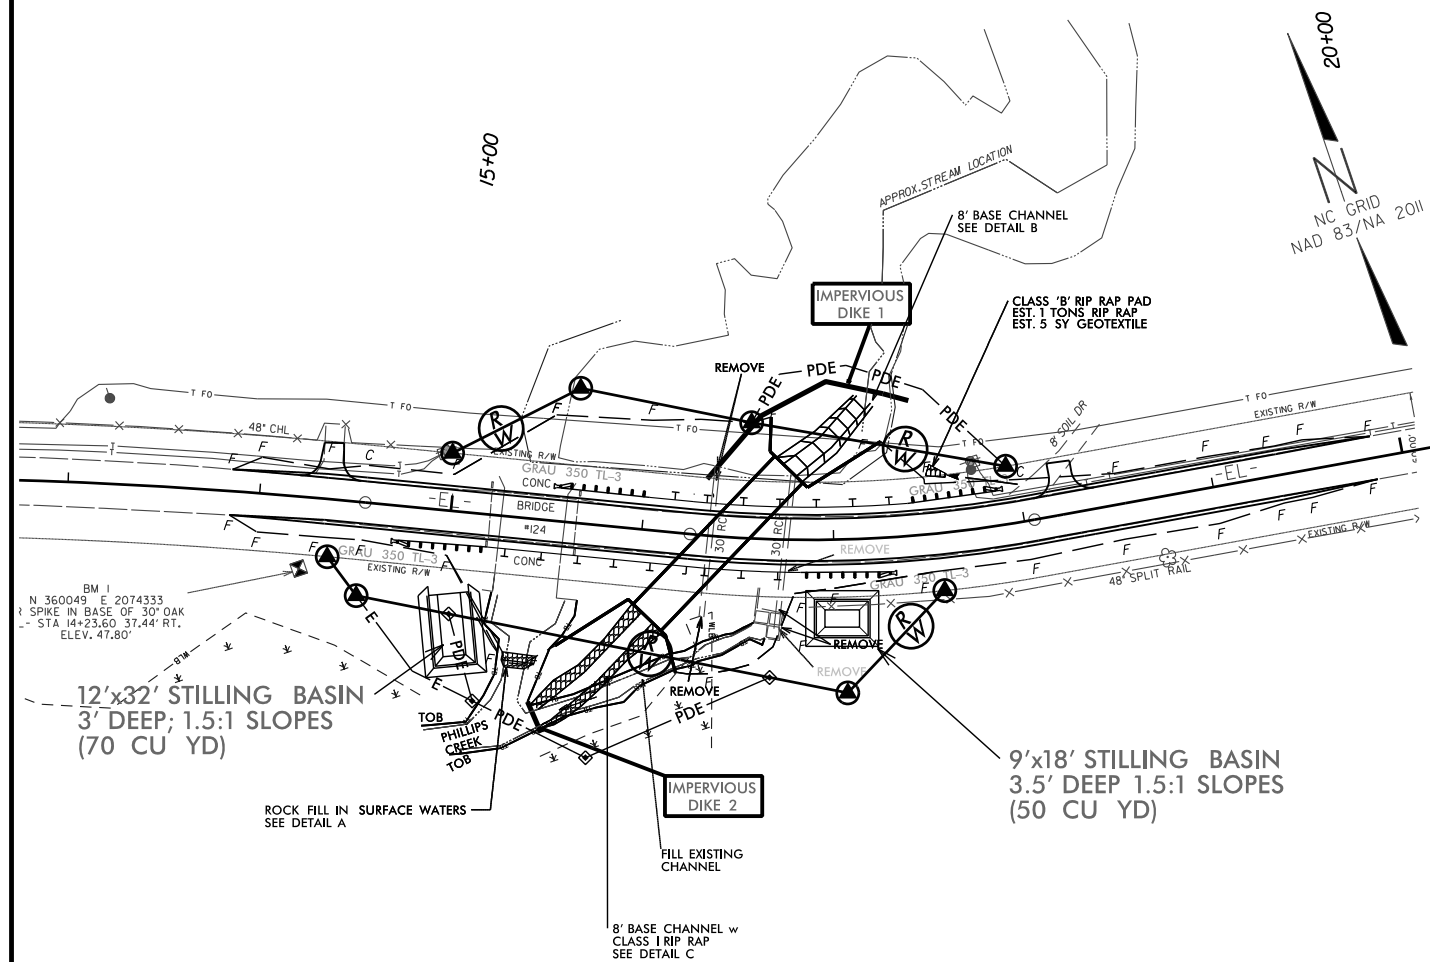


29.708.091

See Sheet 1-A For Index of Sheets

T.I.P. NO.	SHEET NO.
B-5411	UC-1

TIP PROJECT: B-5411

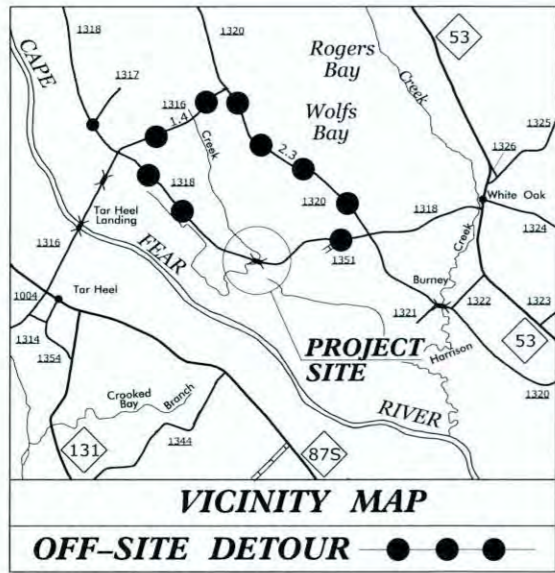


STATE OF NORTH CAROLINA
DIVISION OF HIGHWAYS

UTILITY CONSTRUCTION PLANS BLADEN COUNTY


LOCATION: BRIDGE NO. 124 OVER PHILLIPS CREEK ON SR 1318 (RIVER RD.)
TYPE OF WORK: UTILITIES CONSTRUCTION

UTILITIES CONSTRUCTION

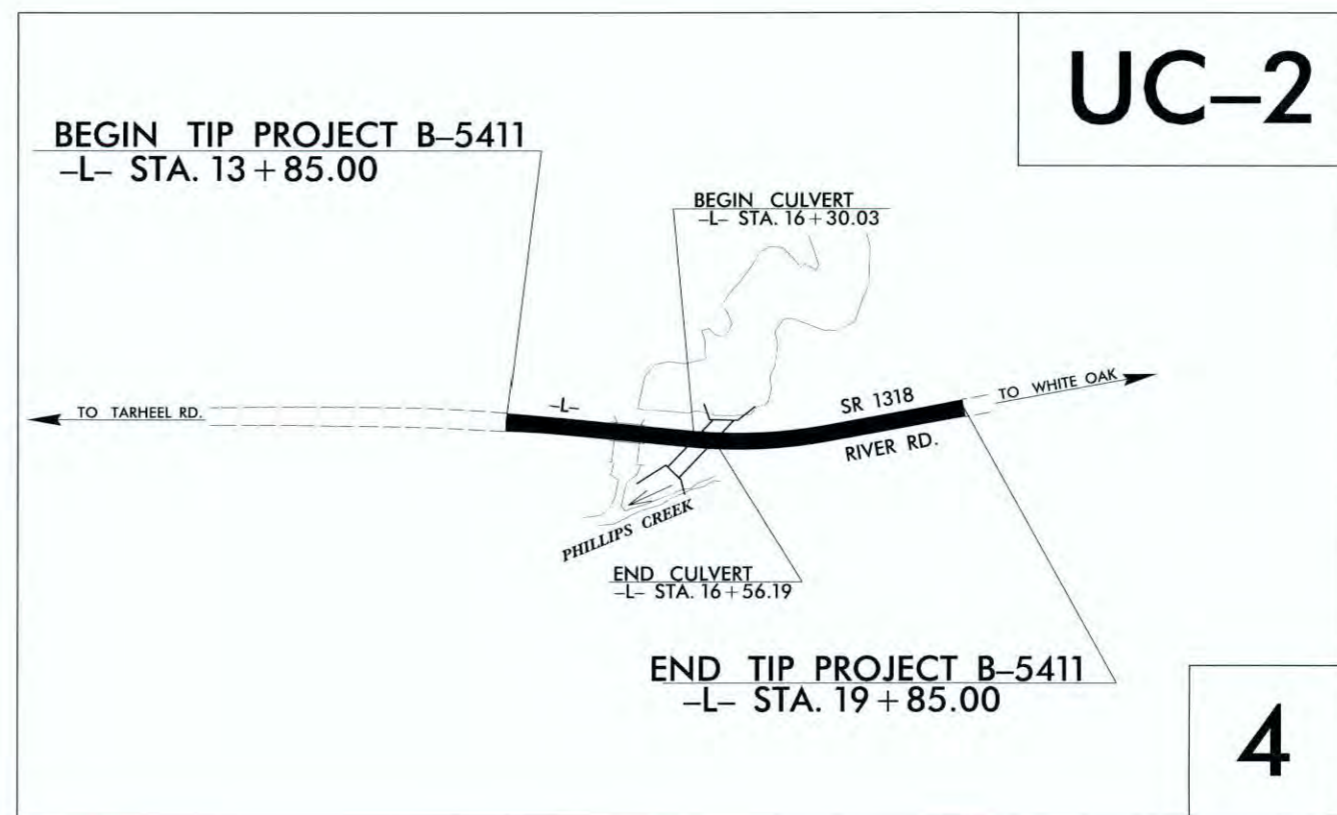

CONTRACT:

CLEARING ON THIS PROJECT SHALL BE PERFORMED TO THE LIMITS ESTABLISHED BY METHOD
THIS PROJECT IS NOT WITHIN ANY MUNICIPAL BOUNDARIES.

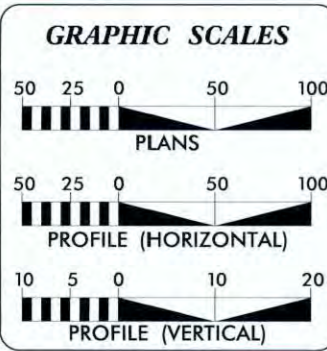

INDEX OF SHEETS

SHEET NO.	DESCRIPTION
UC-1	TITLE SHEET
UC-2	PLAN & PROFILE SHEET

WATER AND SEWER OWNERS ON PROJECT

(1) WATER - BLADEN COUNTY PUBLIC WORKS

Prepared for the North Carolina Department of Transportation in the Office of:
559 JONES FRANKLIN ROAD
STATE 164
Raleigh, N.C. 27606
License No. F-0377
Box 979 851 8077
Fax 919 851 8107

WETHERILL ENGINEERING

2012 STANDARD SPECIFICATIONS

RIGHT OF WAY DATE: _____

LETTING DATE: _____

EDWARD G. WETHERILL, PE
PROJECT ENGINEER

GREG S. PURVIS, PE
PROJECT DESIGN ENGINEER

MICHAEL V. ZACCARDO, PE
UTILITY DESIGN ENGINEER



SYSTEMS TIME \$\$\$\$
PLOT \$\$\$\$
CUST. NAME \$\$\$\$

PROJECT REFERENCE NO.	SHEET NO.
B-5411	UC-2
DESIGNED BY: MVZ	
DRAWN BY: JDS	
CHECKED BY: MVZ	
APPROVED BY: MVZ	
REVISED:	
NORTH CAROLINA DEPARTMENT OF TRANSPORTATION	
UTILITIES ENGINEERING SECTION	
PHONE: (919) 707-6690	UTILITY CONSTRUCTION PLANS ONLY
FAX: (919) 250-4151	

UTILITY CONSTRUCTION


ETHERILL ENGINEERING
 559 Jones Franklin Rd. Suite 164
 Raleigh, N.C. 27604
 License No. F-0377
 Box 919 B51 8077
 Fax: 919 851 8107

TRANSPORTATION PLANNING/DESIGN - BRIDGE/STRUCTURE DESIGN
 CIVIL/SITE DESIGN - GIS/GPS - CONSTRUCTION OBSERVATION

PARCEL INDEX	
PARCEL NO.	PROPERTY OWNER NAME
1	ROCKING A RANCH, INC
2	ROCKING A RANCH, INC
3	ASTRAKEL INTERNATIONAL, LTD

PI Sta 13+21.69
 $\Delta = 5^{\circ} 34' 02.1''$ (RT)
 $D = 2^{\circ} 05' 00.5''$
 $L = 267.21'$
 $T = 133.71'$
 $R = 2,750.00'$
 $SE = EXIST.$
 $RO = SEE PLANS$


PI Sta 17+15.83
 $\Delta = 15^{\circ} 53' 18.9''$ (LT)
 $D = 8^{\circ} 48' 53.0''$
 $L = 180.25'$
 $T = 90.71'$
 $R = 650.00'$
 $SE = 0.06$ FT/FT
 $RO = SEE PLANS$

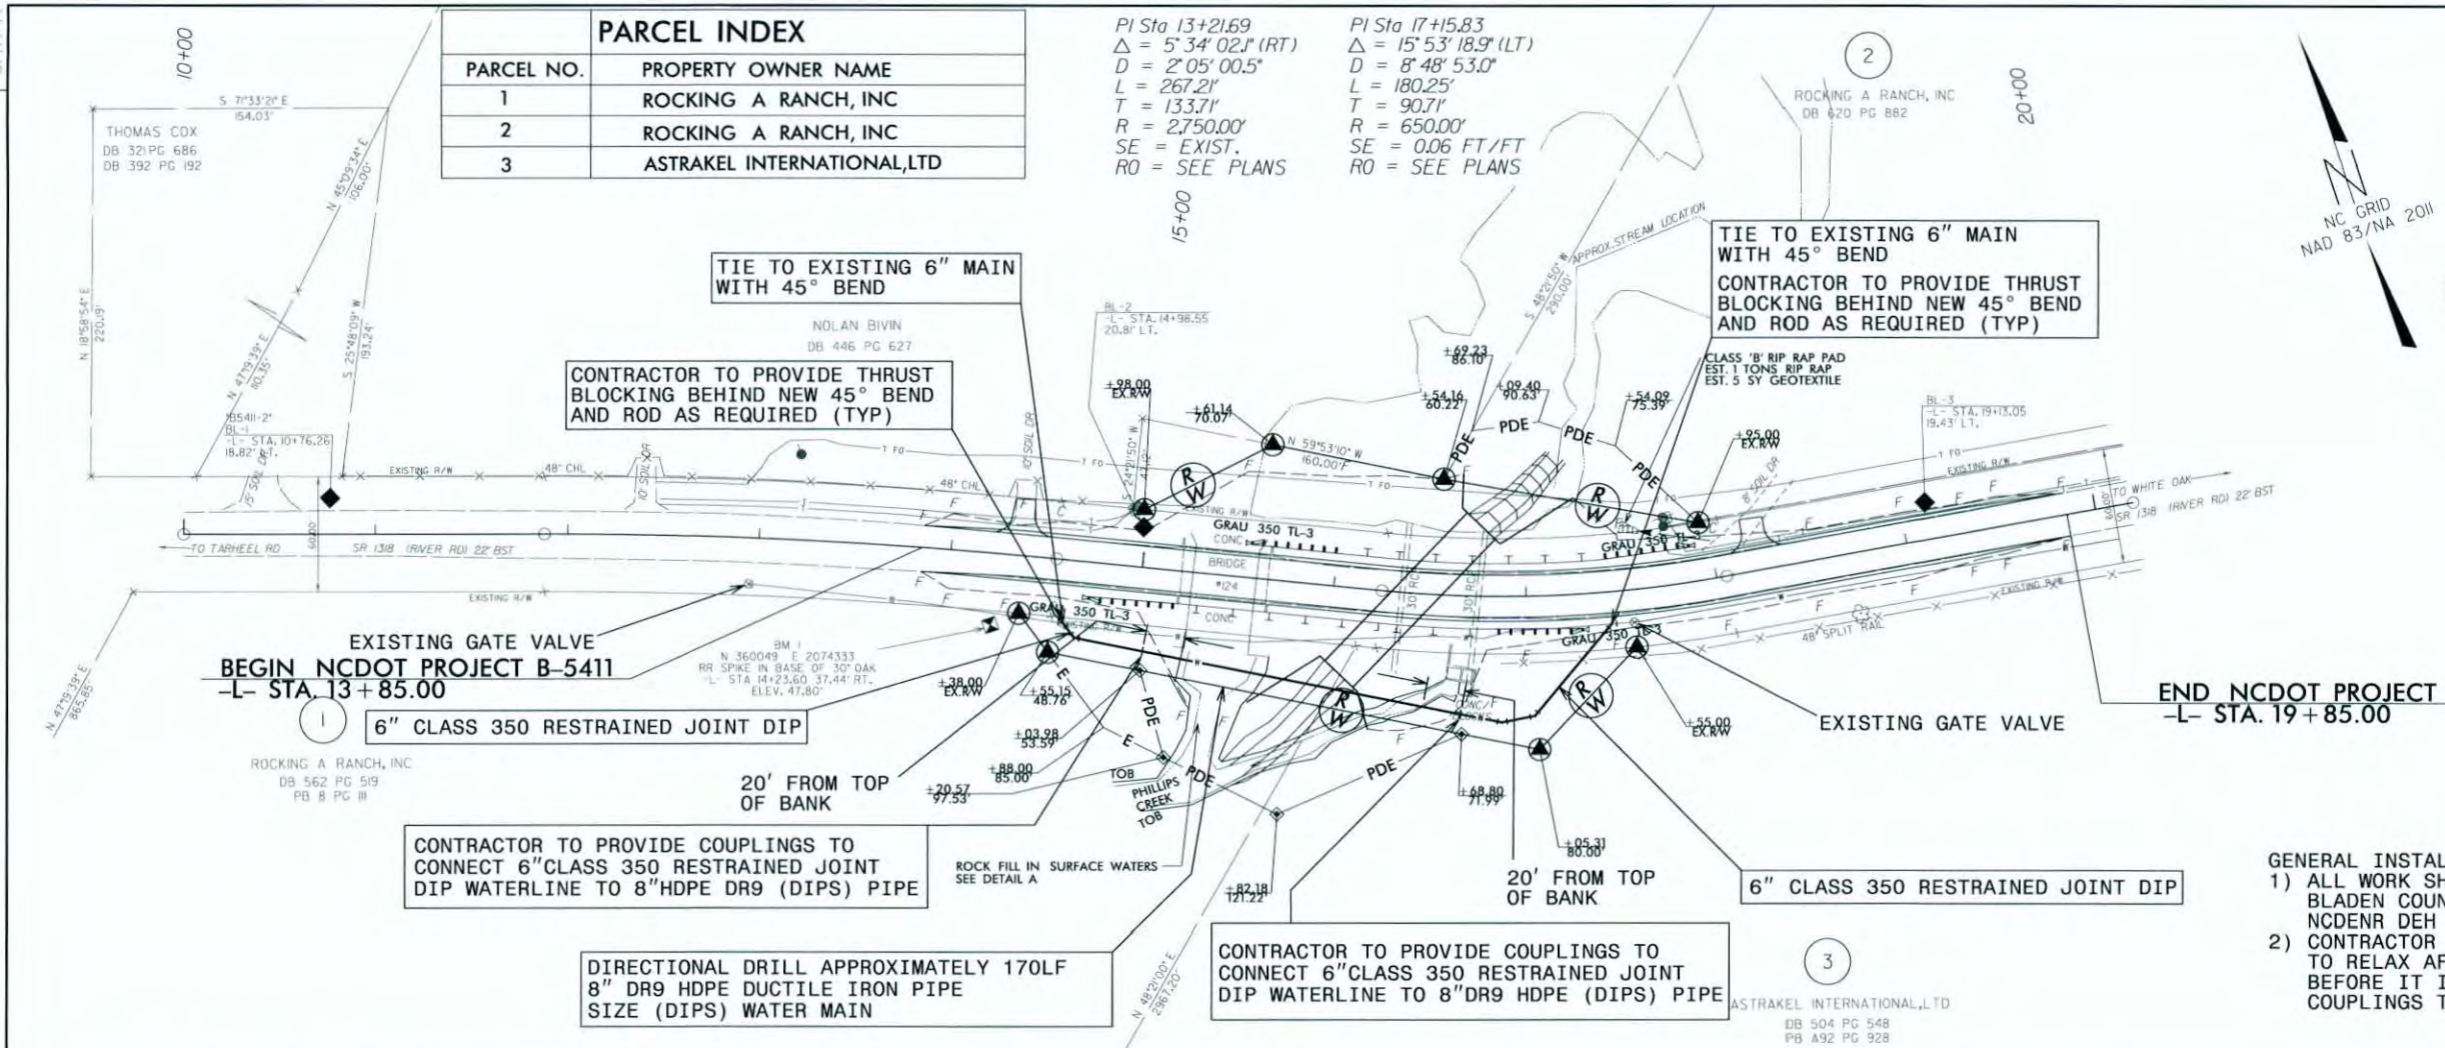

- GENERAL INSTALLATION NOTES:**
- 1) ALL WORK SHALL BE IN ACCORDANCE WITH: BLADEN COUNTY PUBLIC WORKS STANDARDS NCDENR DEH PWS SECTION STANDARDS
 - 2) CONTRACTOR SHALL ALLOW HDPE PIPE 24 HOURS TO RELAX AFTER PULLING IS COMPLETE AND BEFORE IT IS CONNECTED VIA TRANSITION COUPLINGS TO THE OTHER DI PIPE

- WATER INSTALLATION NOTES:**
- 1) CONTRACTOR SHALL COORDINATE ALL PROPOSED WORK WITH BLADEN COUNTY PUBLIC WORKS DIRECTOR PRIOR TO BEGINNING WORK.
 - 2) CONTRACTOR SHALL FULLY INSTALL, PRESSURE & LEAKAGE TEST, AND CHLORINATE NEW WATER MAIN PRIOR TO CONNECTION TO EXISTING SYSTEM.
 - 3) ONCE NEW WATER MAIN IS PRESSURE TESTED AND CHORINATED, CONTRACTOR SHALL LOCATE NEAREST GATE VALVES ON EACH SIDE OF THIS RELOCATION AND TEMPORARILY SHUT DOWN WATER MAIN.
 - 4) TIE NEW WATER MAIN INTO EXISTING WITH USE OF 45° HORIZONTAL BENDS. INSTALL THRUST BLOCKS AND RODDING AS REQUIRED BY BLADEN COUNTY STANDARDS.
 - 5) NEW WATER MAIN SHALL NOT TO BE CONNECTED TO EXISTING MAIN WITHOUT PRIOR APPROVAL AND COORDINATION WITH BLADEN COUNTY.
 - 6) CONTRACTOR SHALL PERFORM THE CONNECTION DURING OFF PEAK HOURS WITH A MAXIMUM SHUT DOWN TIME OF SIX HOURS.

SCALE: 1"=50' H
 1"=10' V

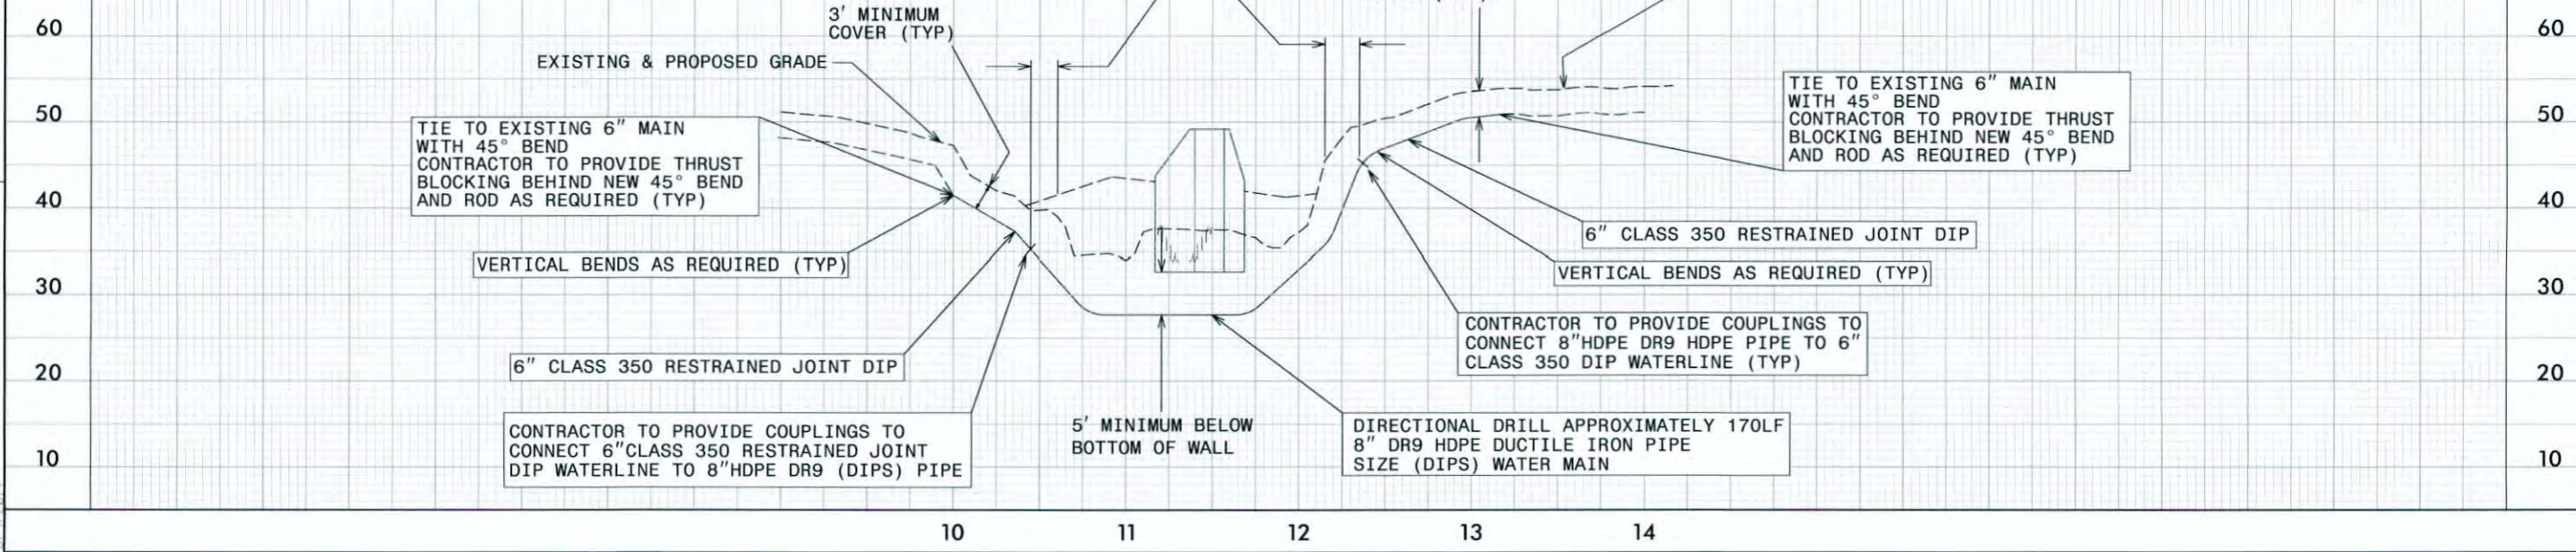

REVISIONS


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 2/27/21

09/08/99

See Sheet 1-A For Index of Sheets

T.I.P. NO.	SHEET NO.
B-5411	UO-1

TIP PROJECT: B-5411

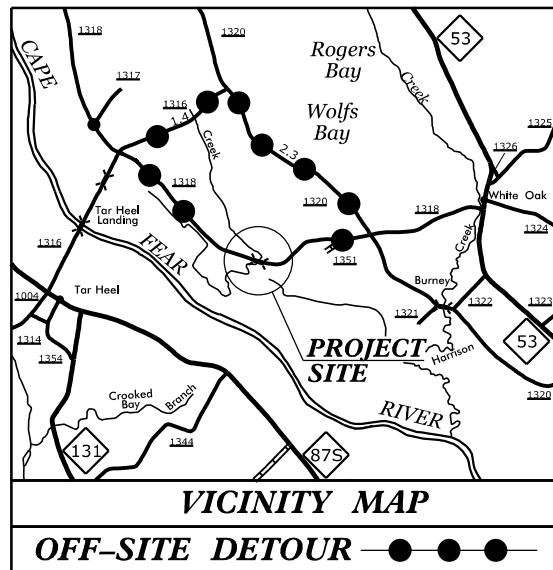


STATE OF NORTH CAROLINA DIVISION OF HIGHWAYS

UTILITIES BY OTHERS PLANS BLADEN COUNTY

LOCATION: BRIDGE NO. 124 OVER PHILLIPS CREEK ON SR 1318 (RIVER RD.)


TYPE OF WORK: UTILITIES RELOCATION

UTILITIES BY OTHERS

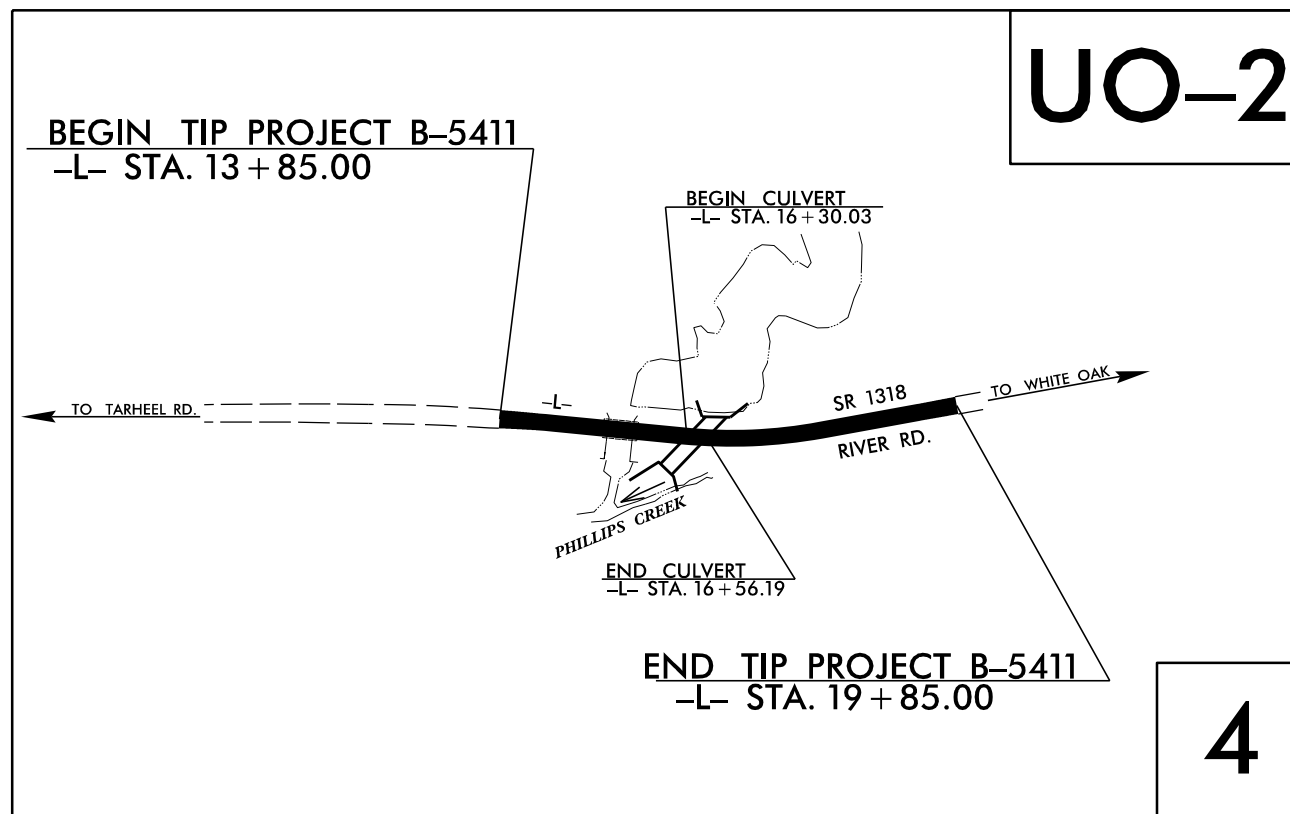

CLEARING ON THIS PROJECT SHALL BE PERFORMED TO THE LIMITS ESTABLISHED BY METHOD . . . THIS PROJECT IS NOT WITHIN ANY MUNICIPAL BOUNDARIES.

CONTRACT:

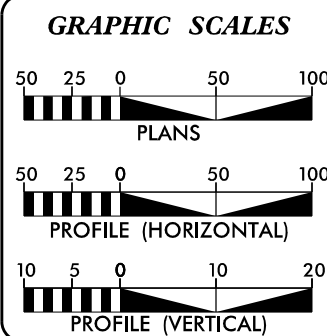

SHEET NO.	DESCRIPTION
UO-1	TITLE SHEET
UO-2	UTILITIES BY OTHERS PLAN SHEET

UTILITY OWNERS ON PROJECT
(A) FOUR COUNTY EMC (POWER TRANSMISSION & DISTRIBUTION)
(B) STAR TELEPHONE (PHONE)

ETHERILL ENGINEERING
Prepared for the North Carolina Department of Transportation in the Office of:
559 JONES FRANKLIN ROAD
SUITE 104
Raleigh, N.C. 27606
License No. F-0377
Bus: 919-851-8077
Fax: 919-851-8007

2012 STANDARD SPECIFICATIONS


RIGHT OF WAY DATE: _____

LETTING DATE: _____

EDWARD G. WETHERILL, PE
PROJECT ENGINEER

GREG S. PURVIS, PE
PROJECT DESIGN ENGINEER


JOHN D. SCHRINER, PLS
UTILITY COORDINATOR

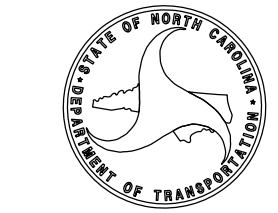

\$\$\$\$\$ SYSTEMS\$\$\$\$\$
\$\$\$\$\$ DDN\$\$\$\$\$
\$\$\$\$\$ USERNAME\$\$\$\$\$

UTILITIES BY OTHERS



NOTE:
ALL PROPOSED UTILITY WORK
SHOWN ON THIS SHEET WILL
BE DONE BY OTHERS



559 Jones Franklin Rd. Suite 164
Raleigh, N.C. 27606
License No. F-0377
Bus: 919 851 8077
Fax: 919 851 8107

TRANSPORTATION PLANNING/DESIGN - BRIDGE/STRUCTURE DESIGN
CIVIL/SITE DESIGN - GIS/GPS - CONSTRUCTION OBSERVATION

NC GRID
NAD 83/NA 2011

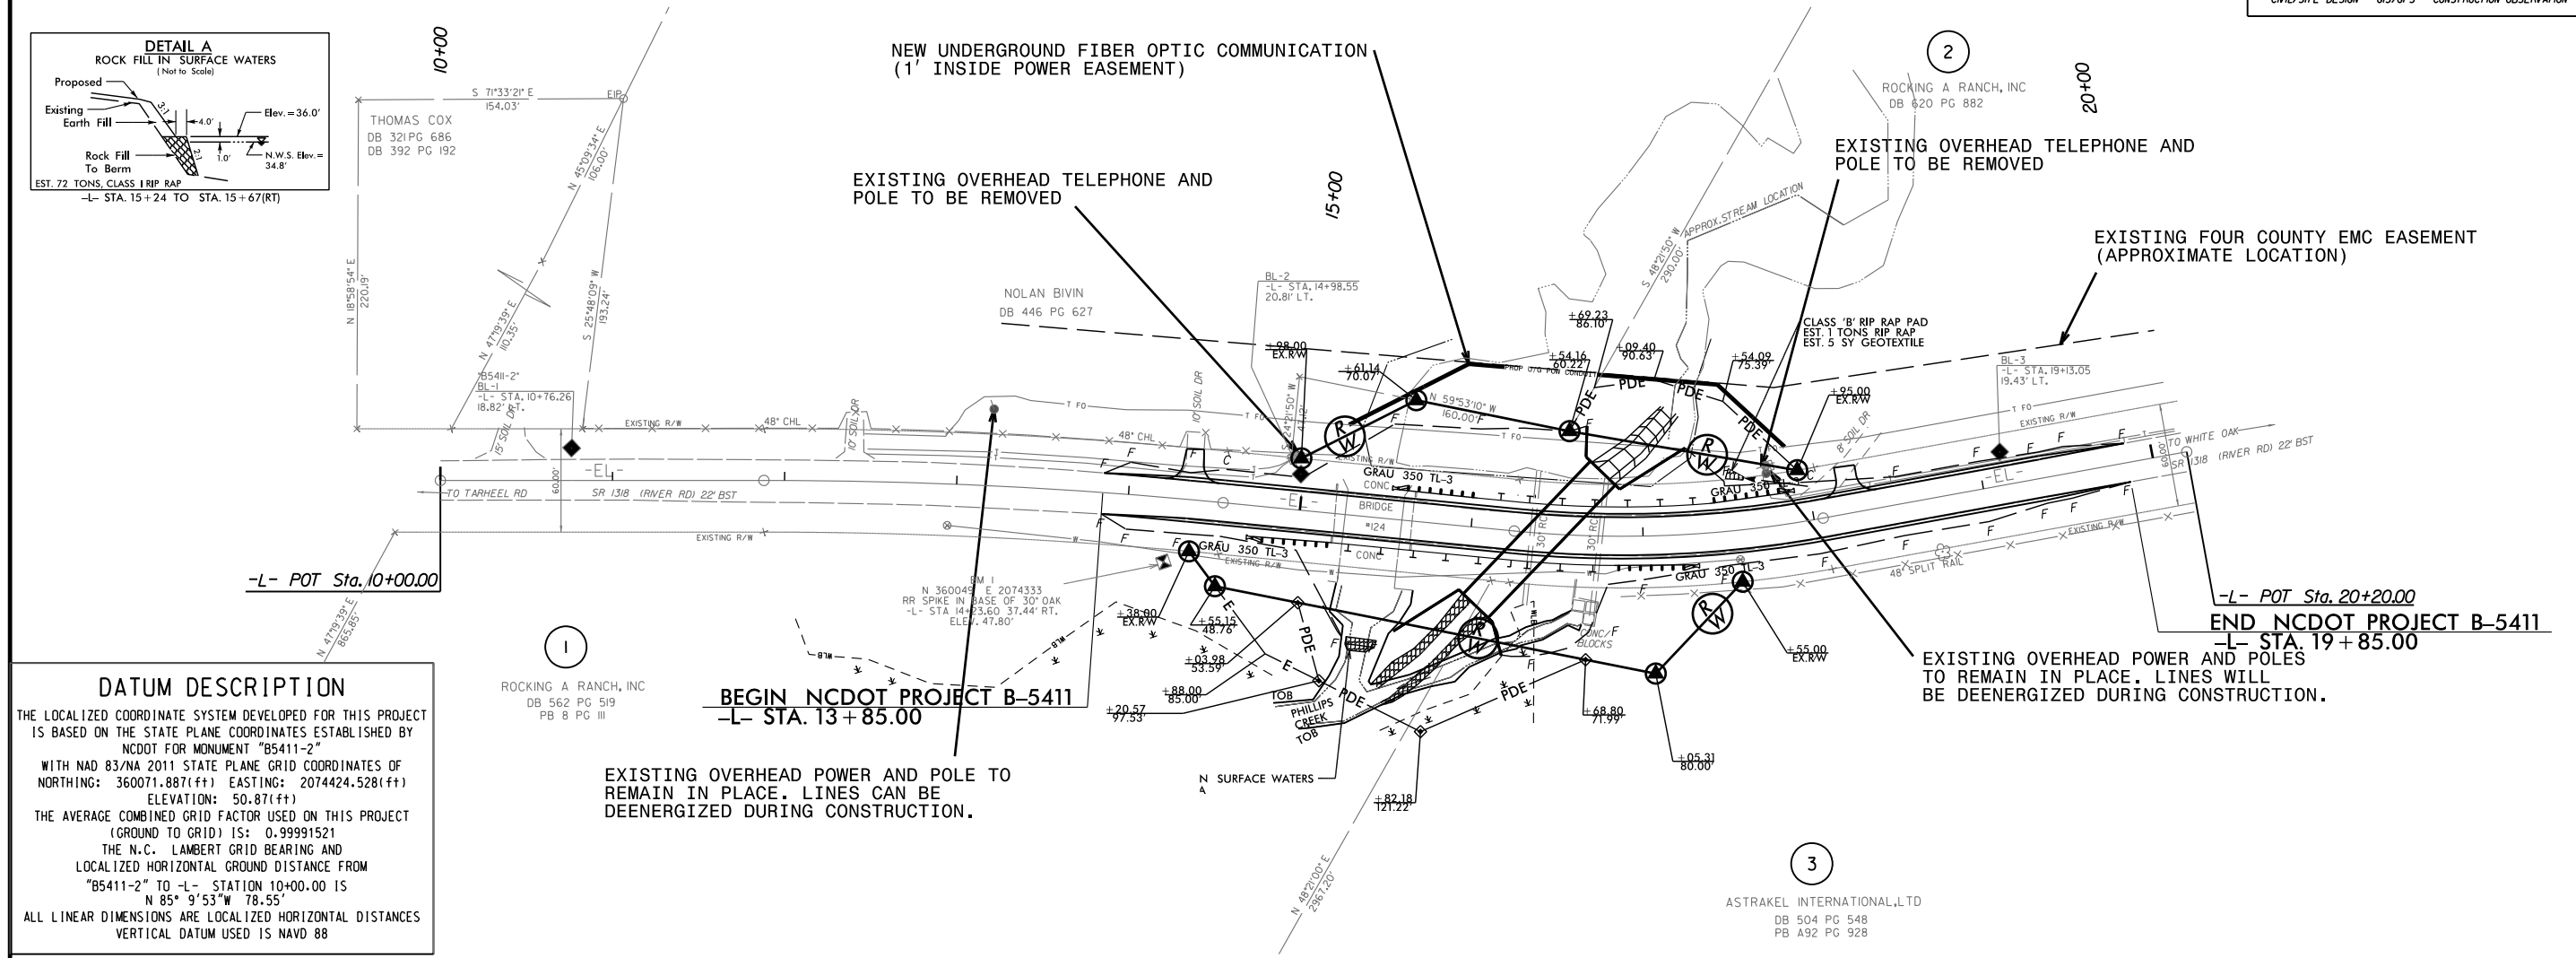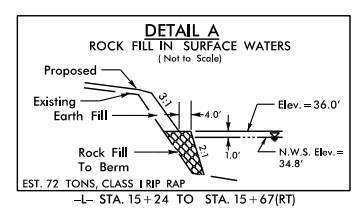

DATUM DESCRIPTION

THE LOCALIZED COORDINATE SYSTEM DEVELOPED FOR THIS PROJECT IS BASED ON THE STATE PLANE COORDINATES ESTABLISHED BY NCDOT FOR MONUMENT "85411-2"

WITH NAD 83/NA 2011 STATE PLANE GRID COORDINATES OF
NORTHING: 360071.887(±) EASTING: 2074424.528(±)
ELEVATION: 50.871(±)

THE AVERAGE COMBINED GRID FACTOR USED ON THIS PROJECT (GROUND TO GRID) IS: 0.99991521

THE N.C. LAMBERT GRID BEARING AND LOCALIZED HORIZONTAL GROUND DISTANCE FROM "85411-2" TO -L- STATION 10+00.00 IS
N 85° 9'53"W 78.55'

ALL LINEAR DIMENSIONS ARE LOCALIZED HORIZONTAL DISTANCES
VERTICAL DATUM USED IS NAVD 88

NOTE: EXISTING OVERHEAD POWER LINES CAN BE TEMPORARILY DEENERGIZED DURING CONSTRUCTION. CONTRACTOR TO NOTIFY FOUR COUNTY EMC 4 WEEKS PRIOR TO BEGINNING CONSTRUCTION.


REVISIONS


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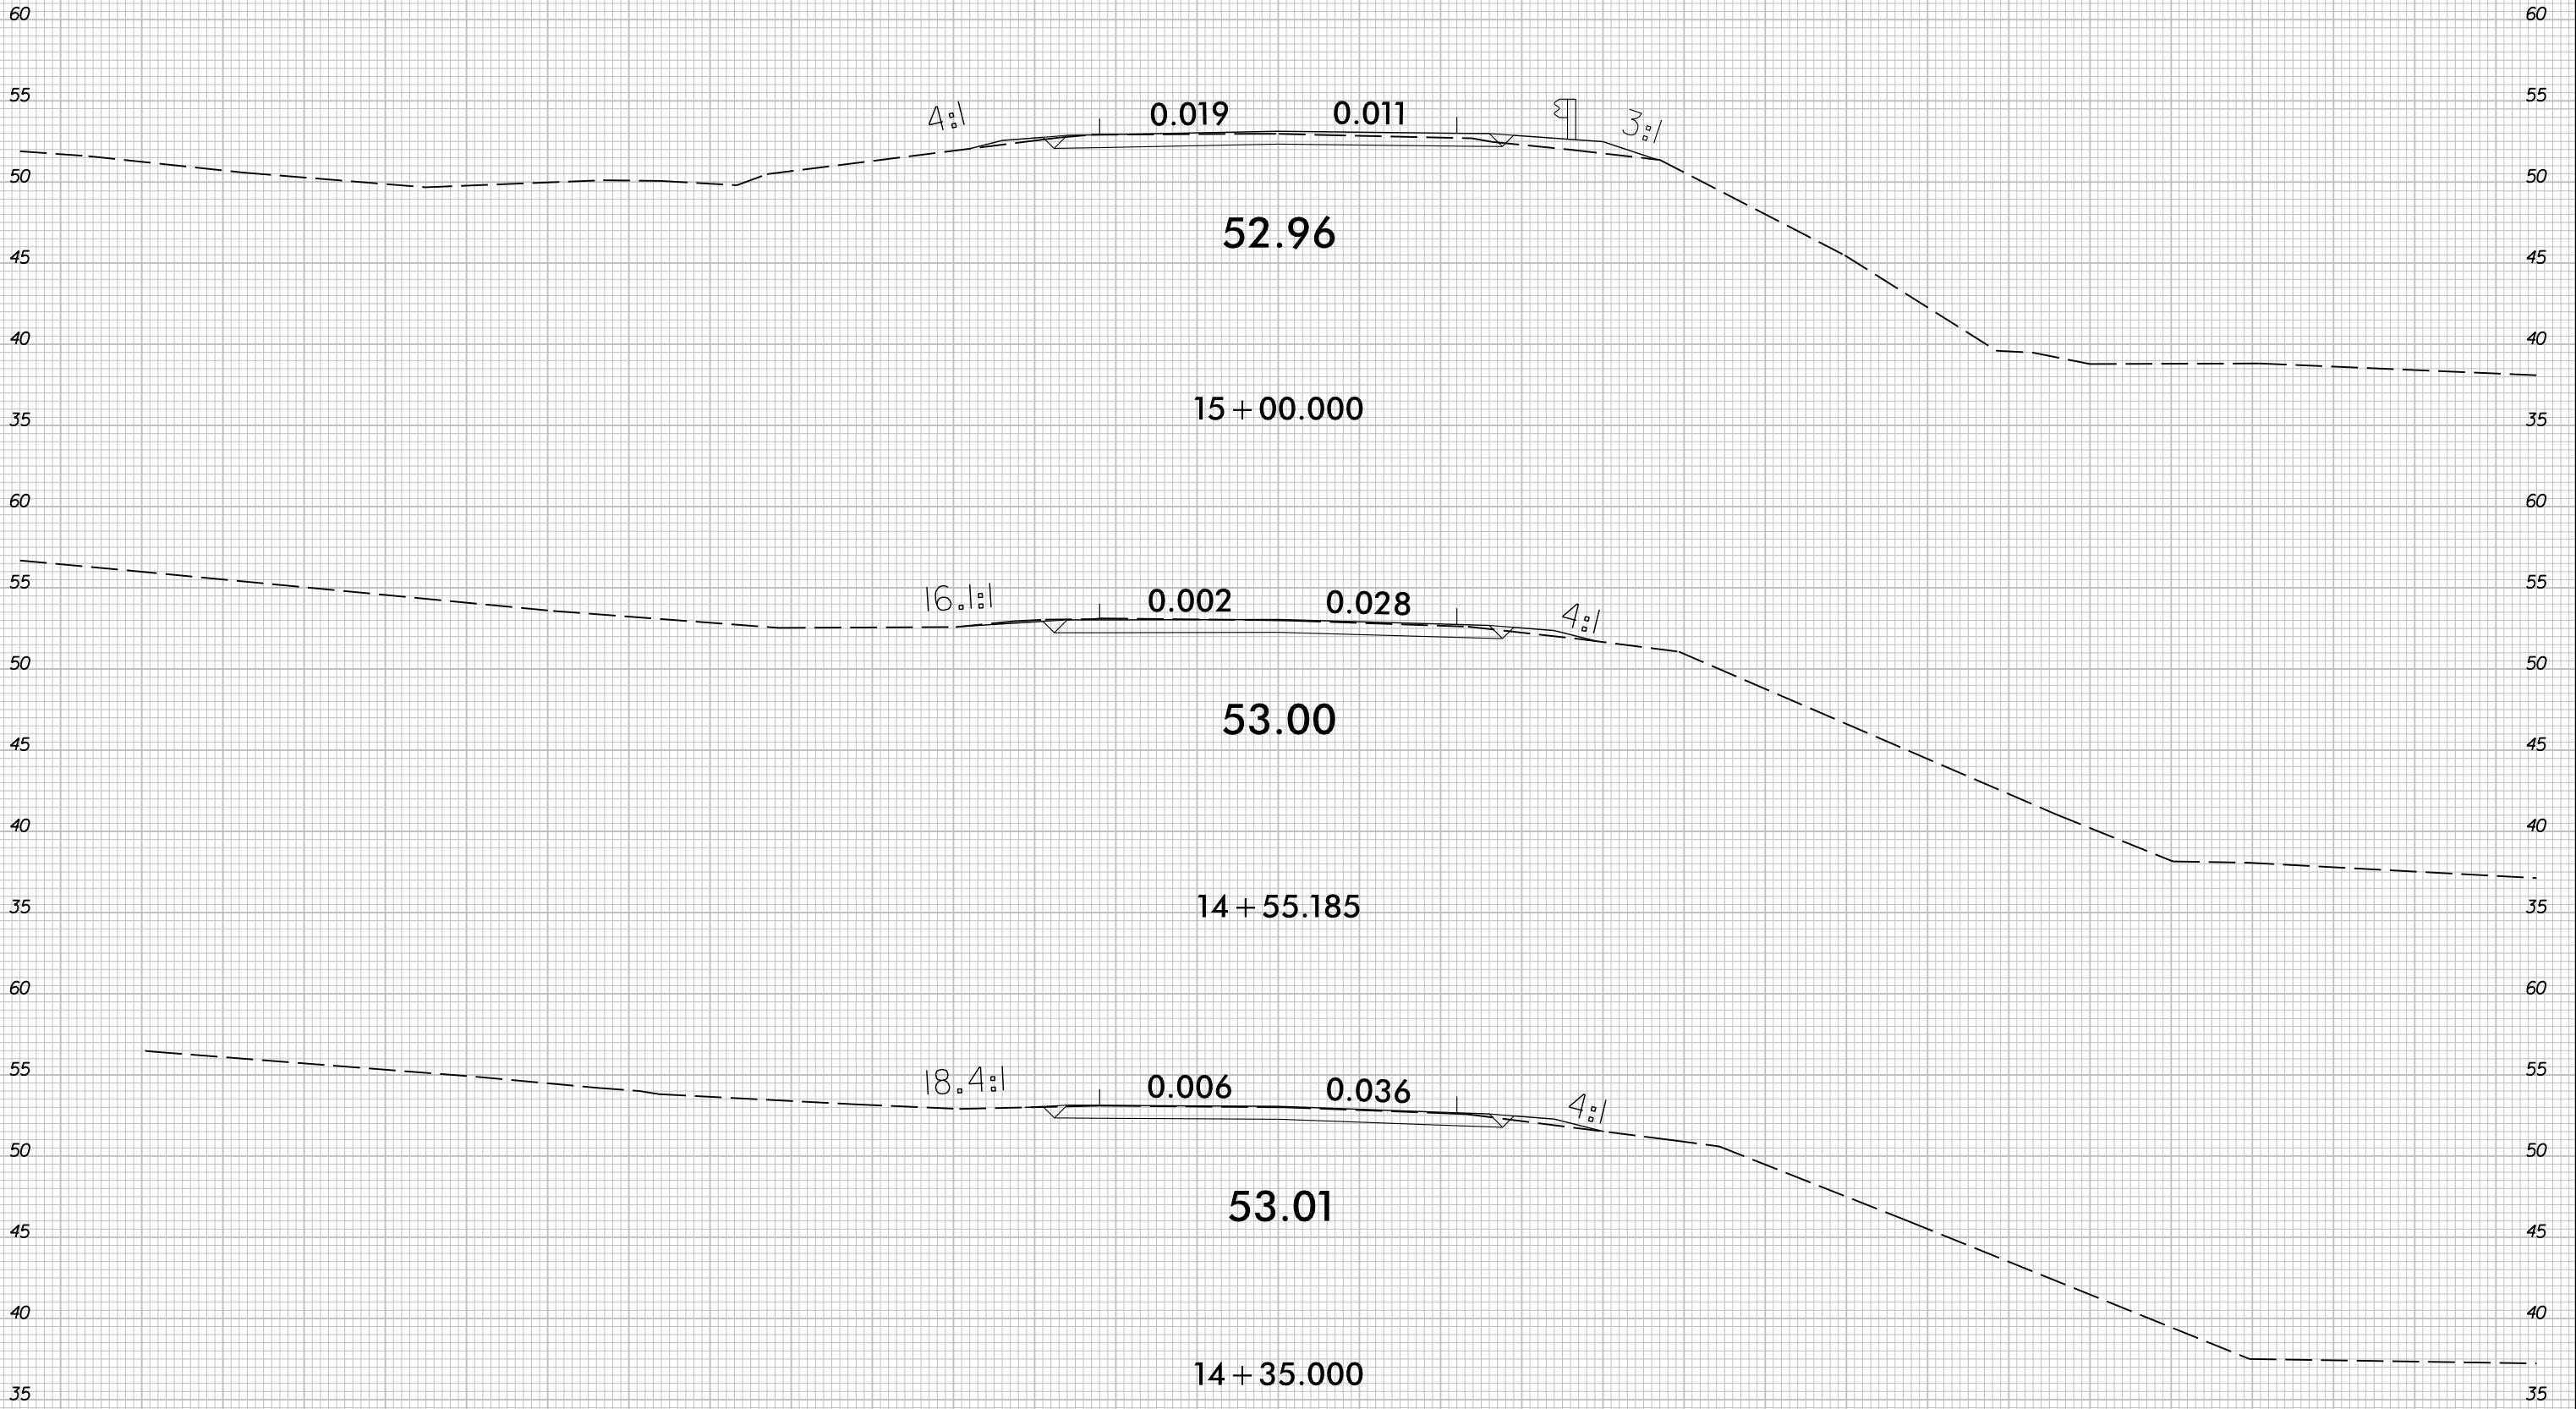


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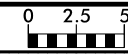


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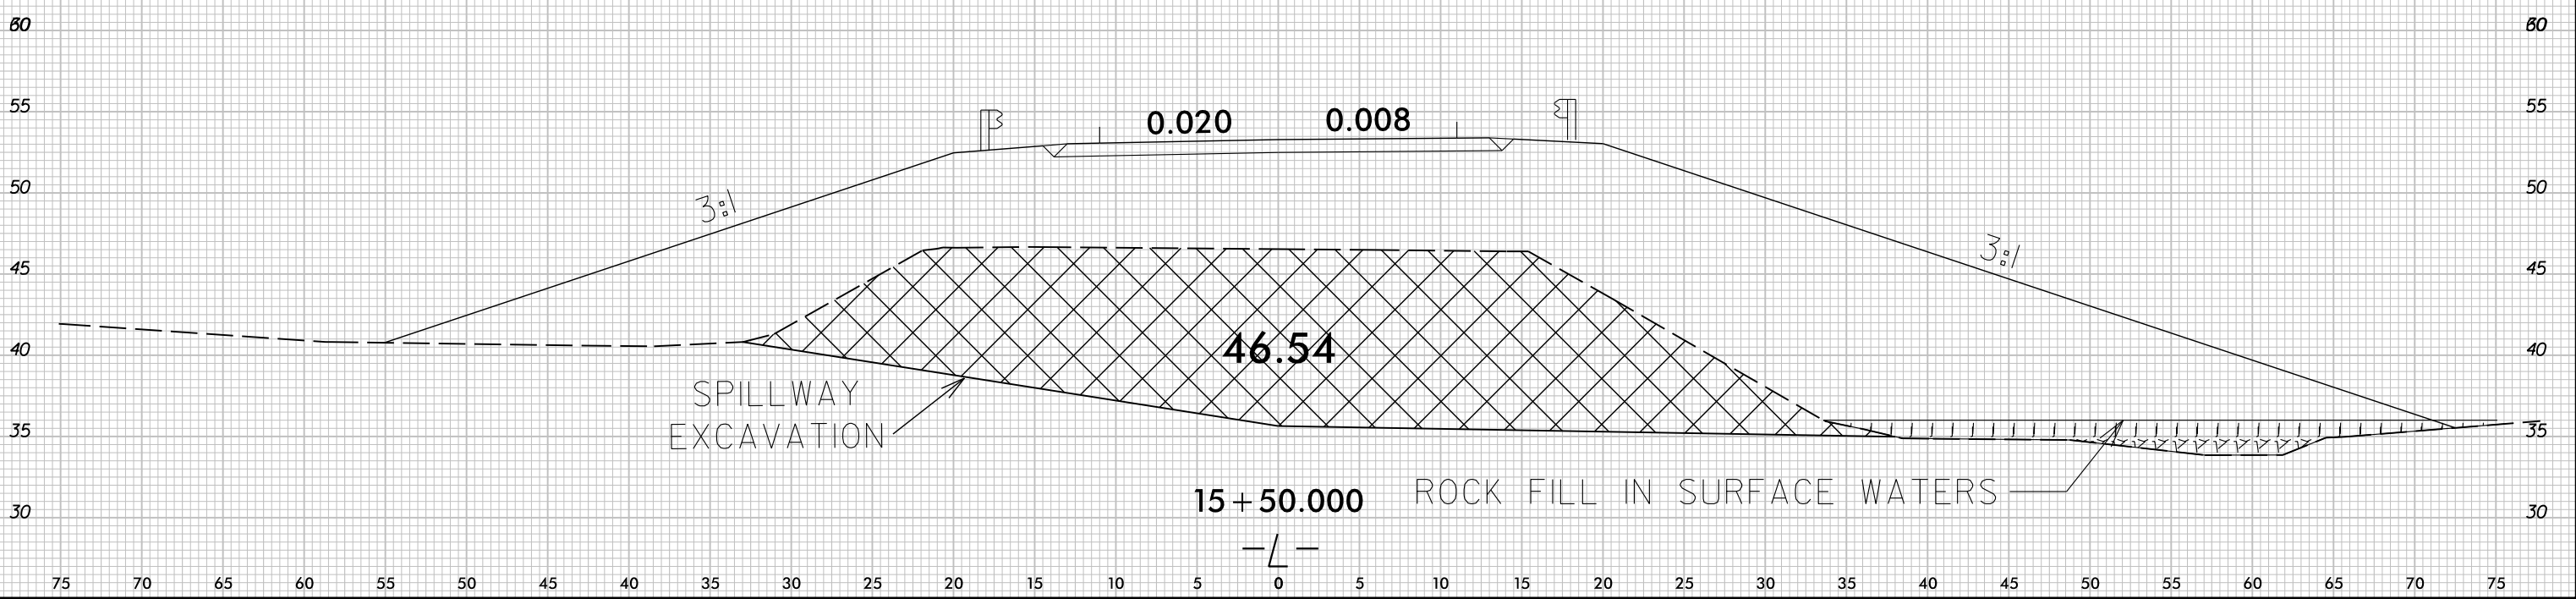
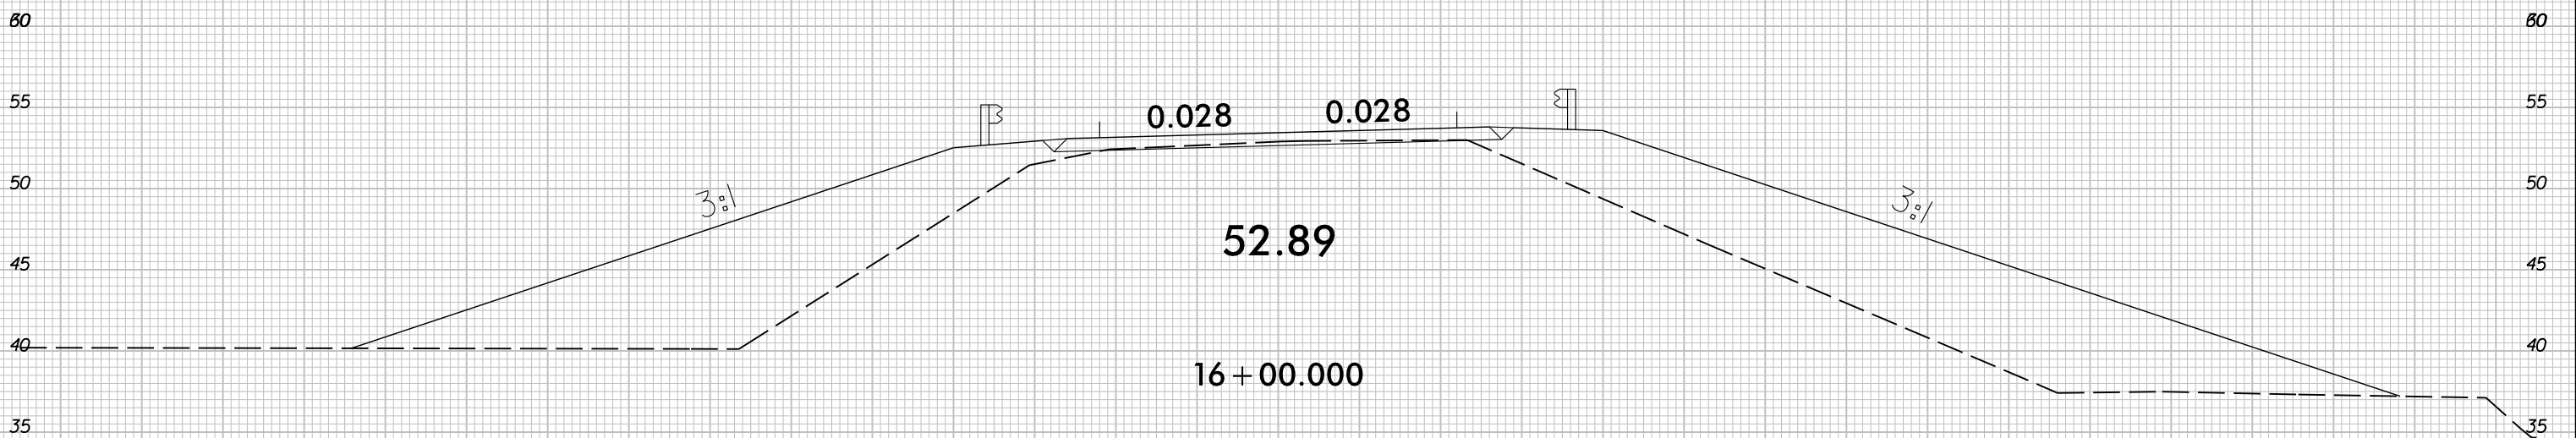
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PROJ. REFERENCE NO.
B-5411


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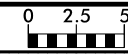
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8/23/99

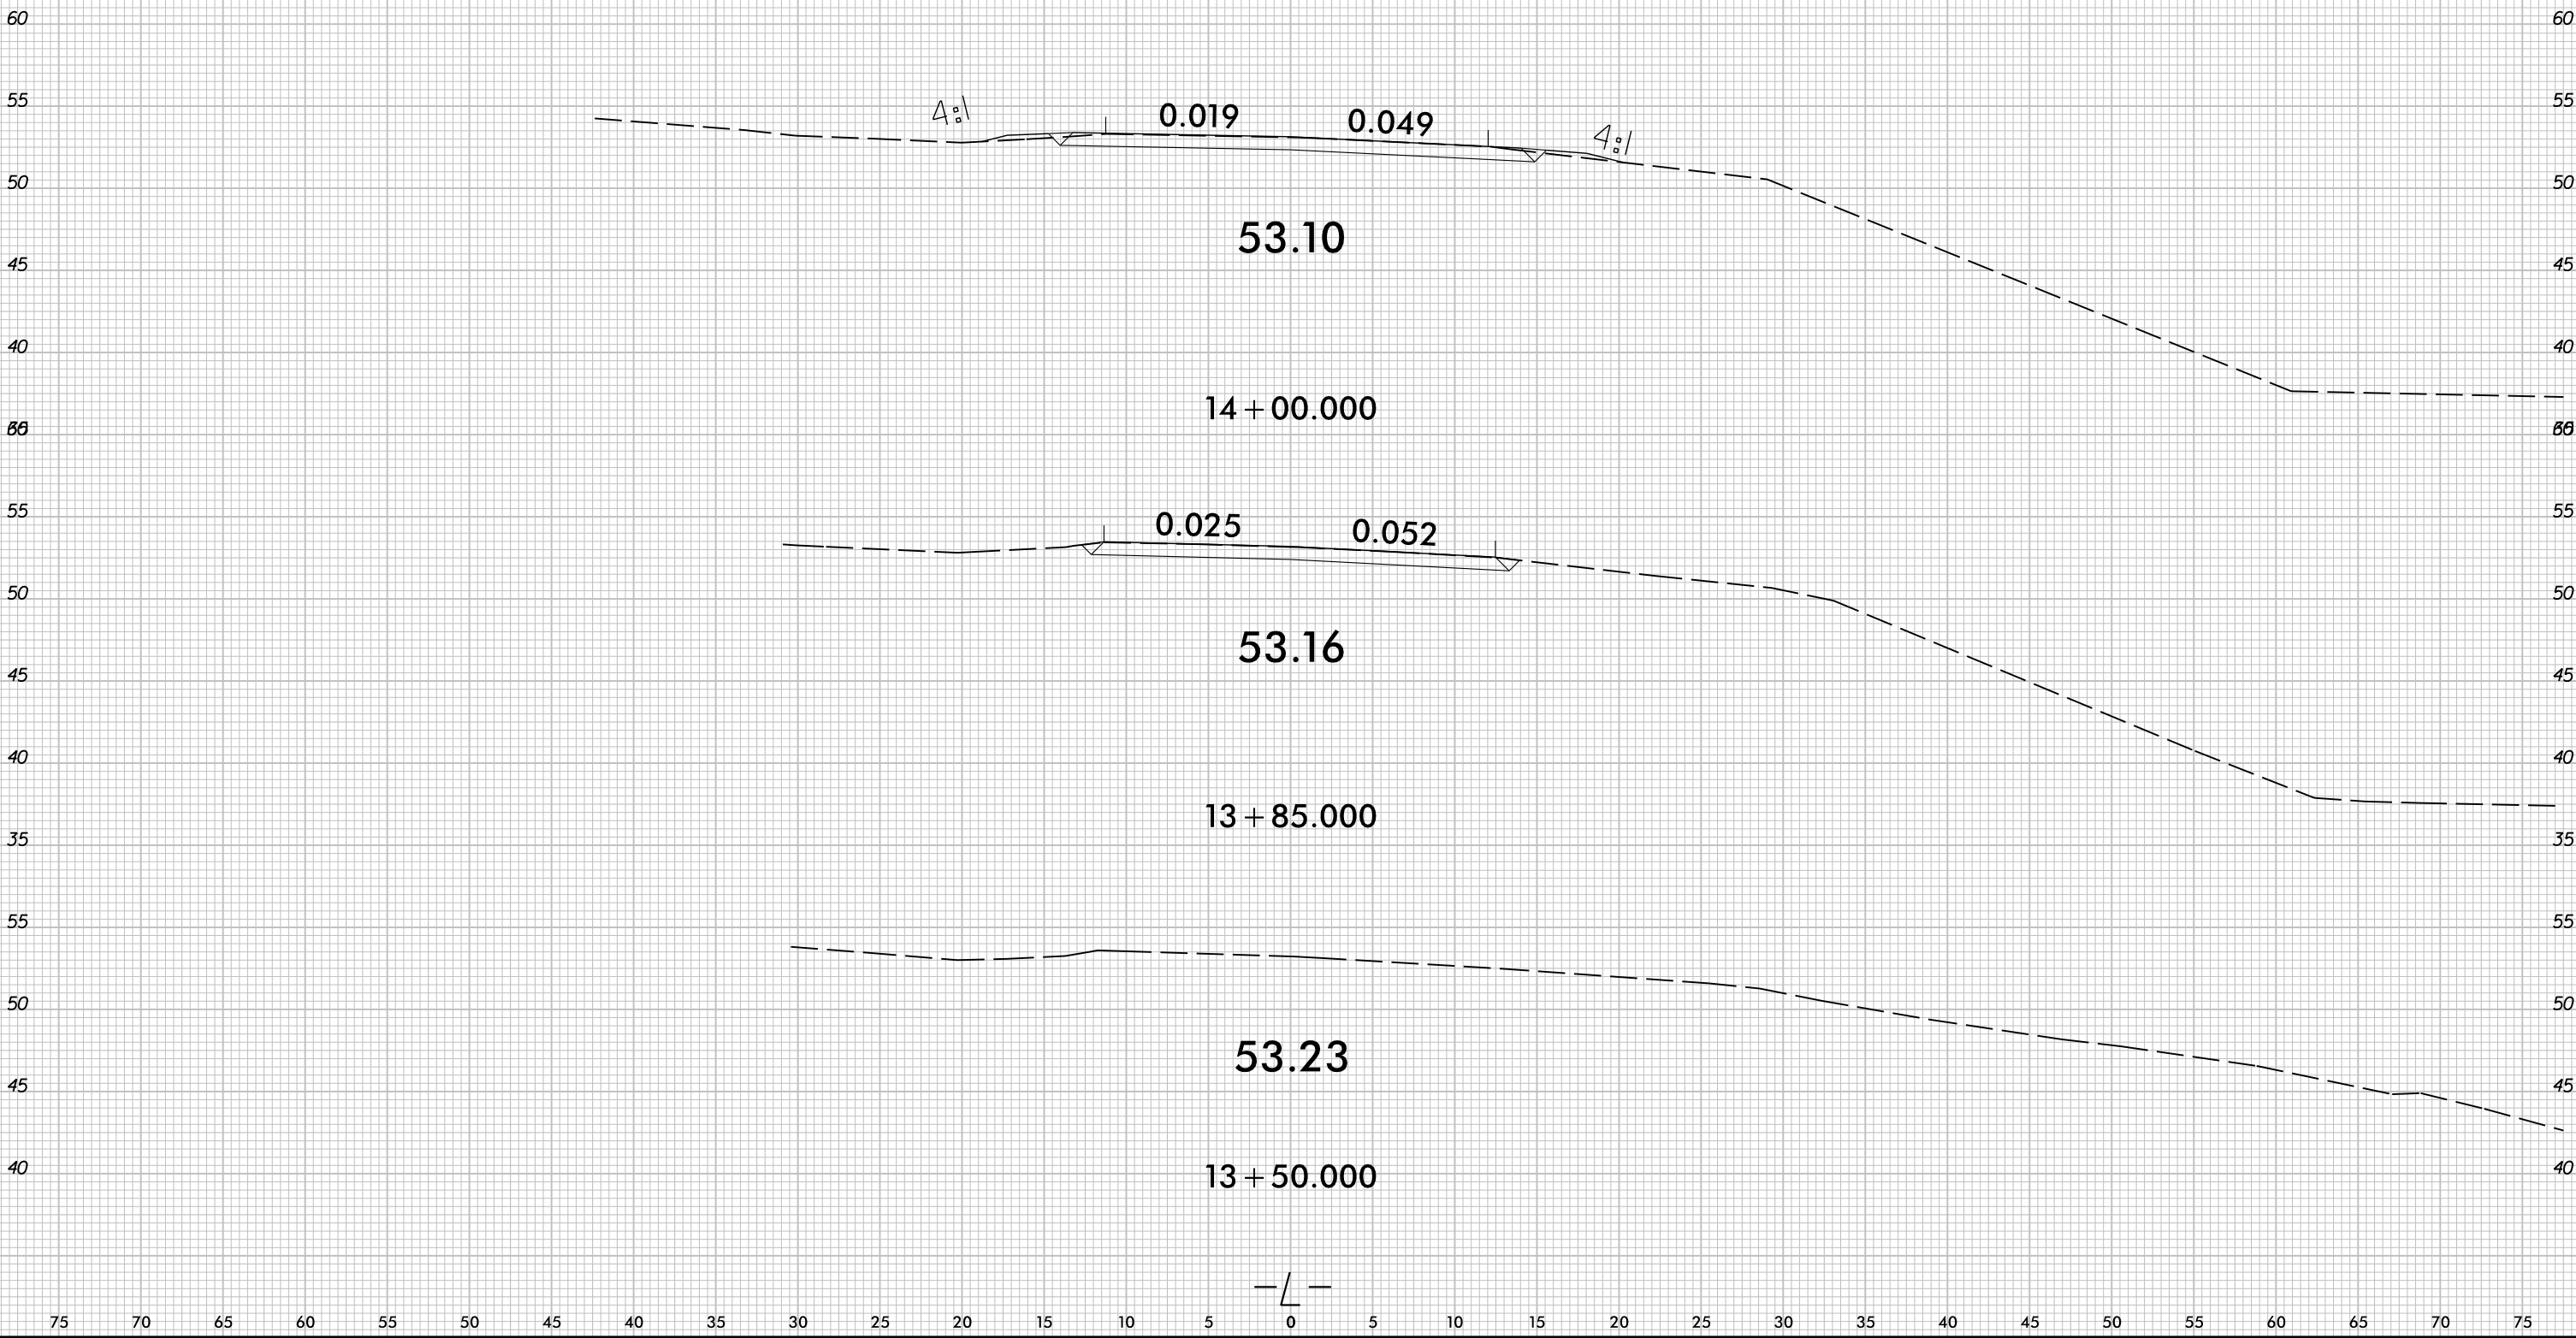
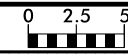
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8/23/99

8/23/99

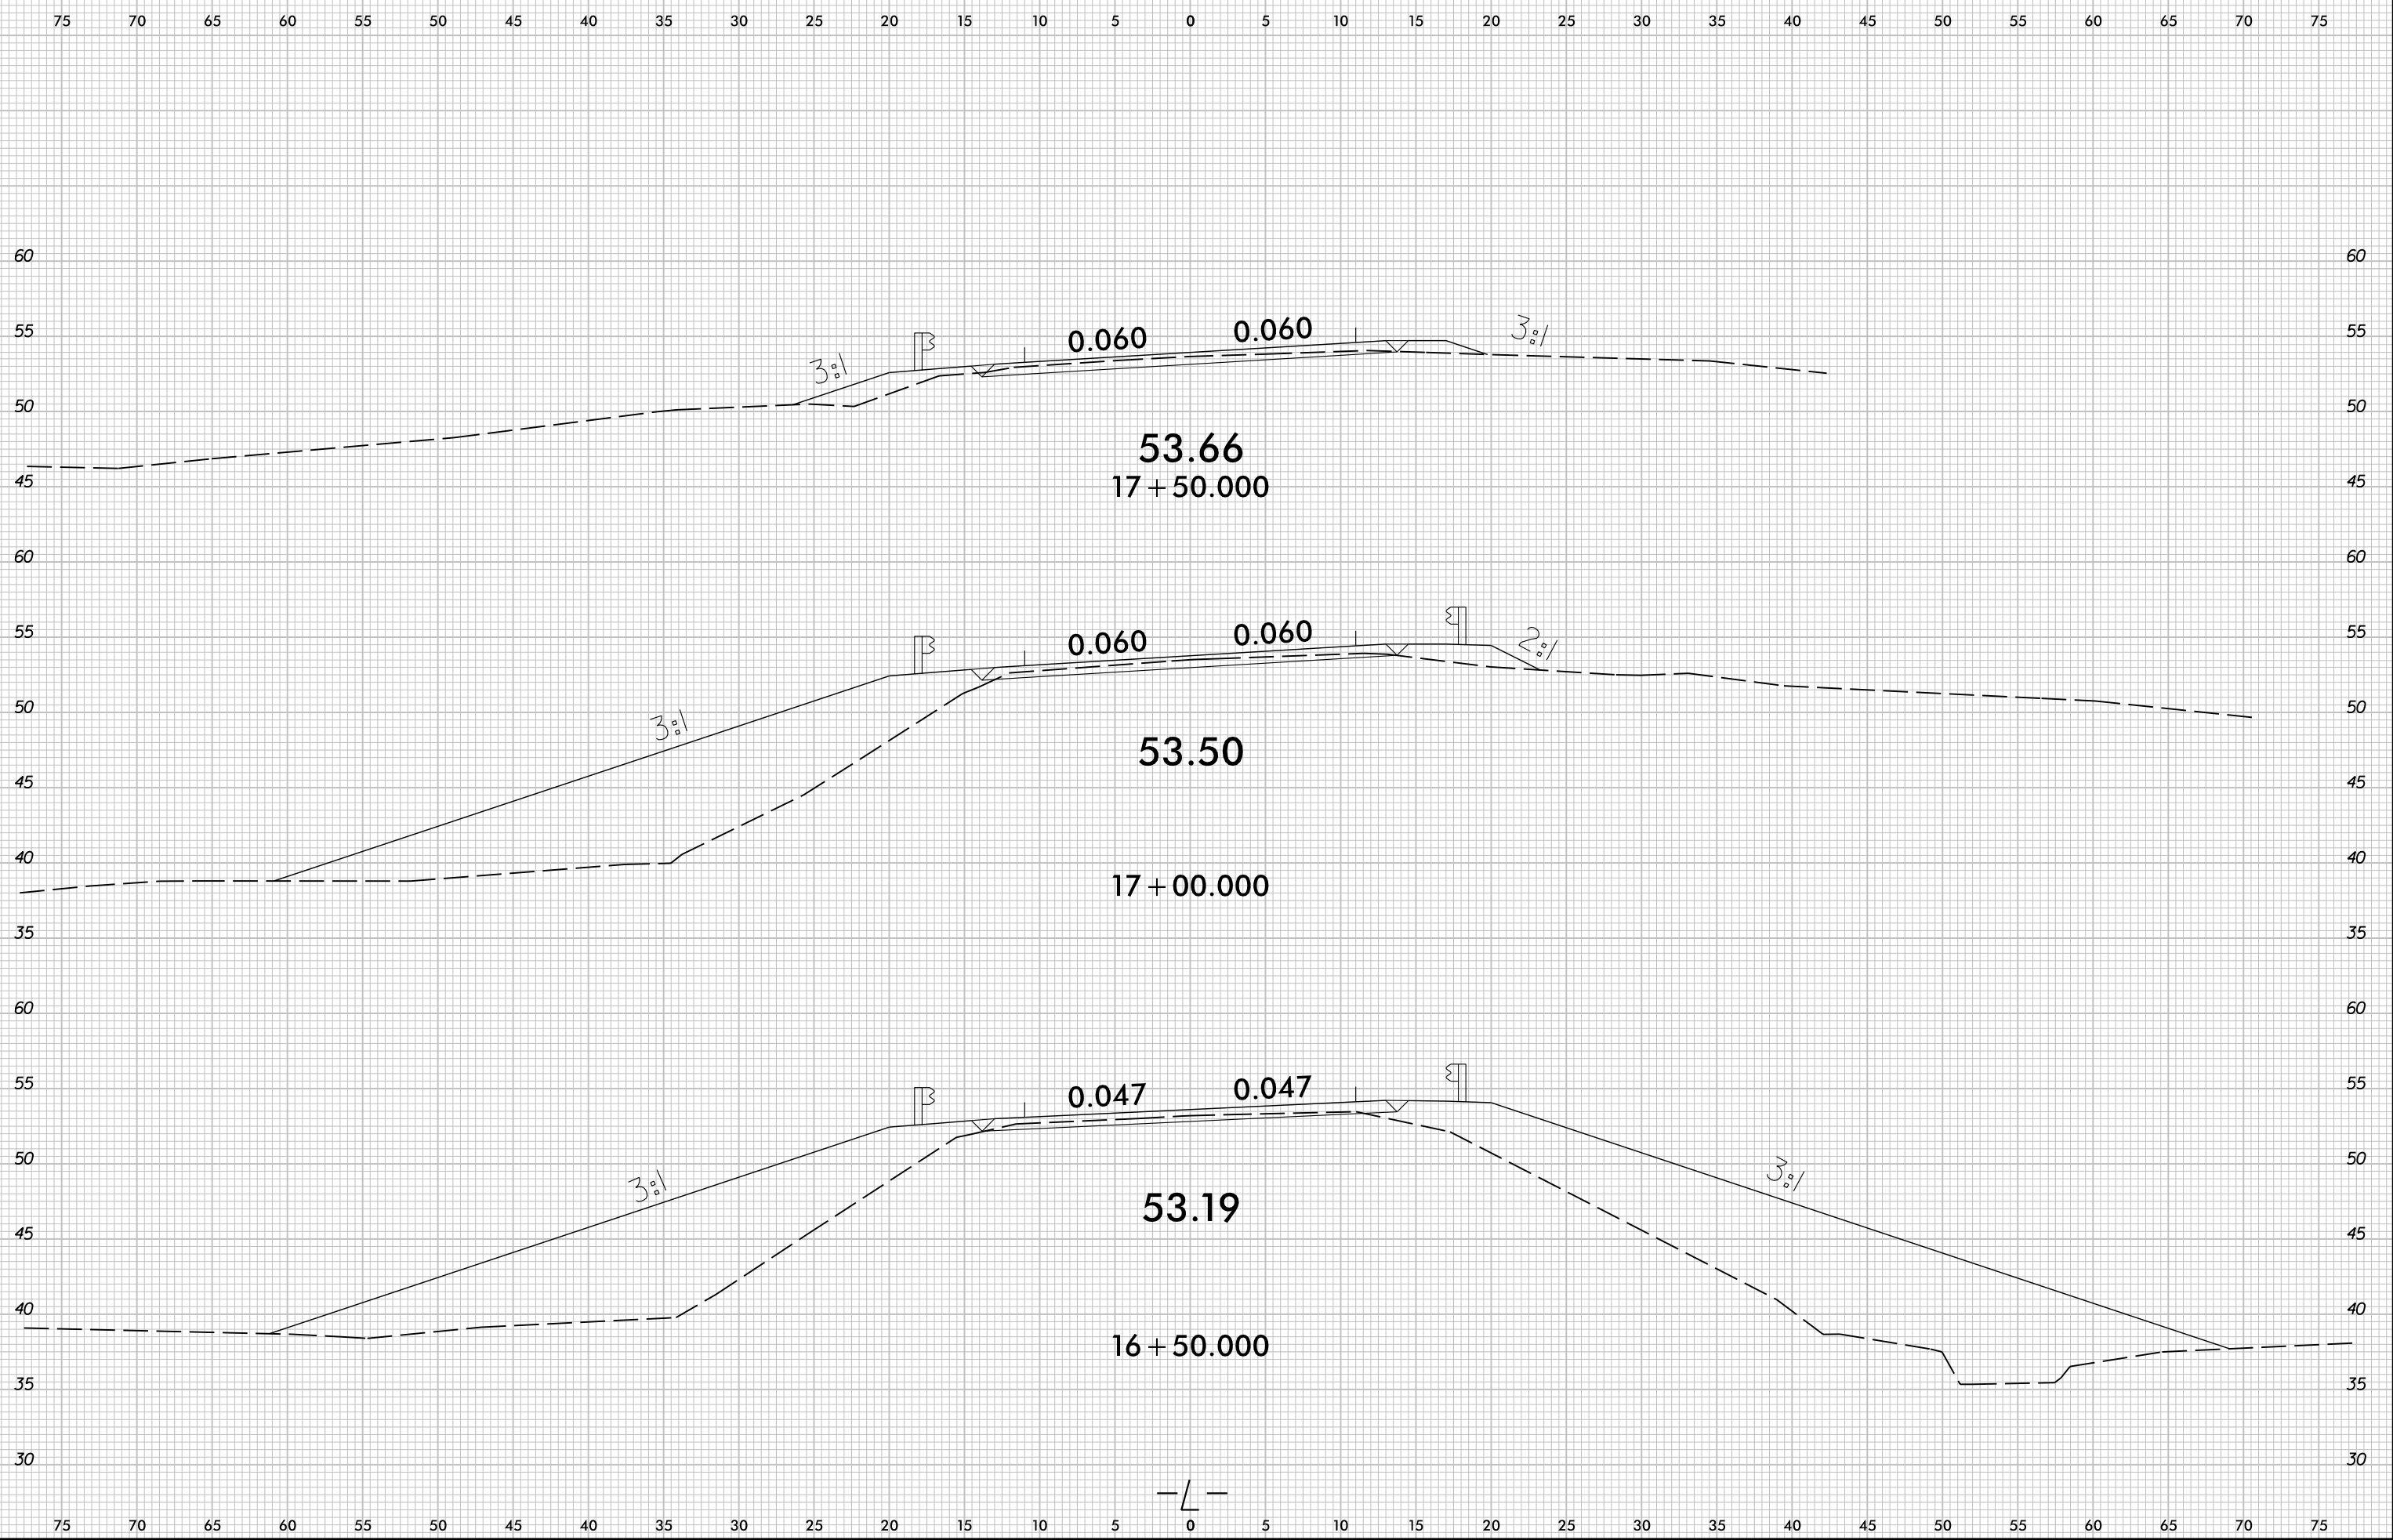

PROJ. REFERENCE NO.
B-5411

SHEET NO.
X-5

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60 60

55 55

50 50

45 45

60 60

55 55

50 50

45 45

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45 45

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53.90
18 + 50.000


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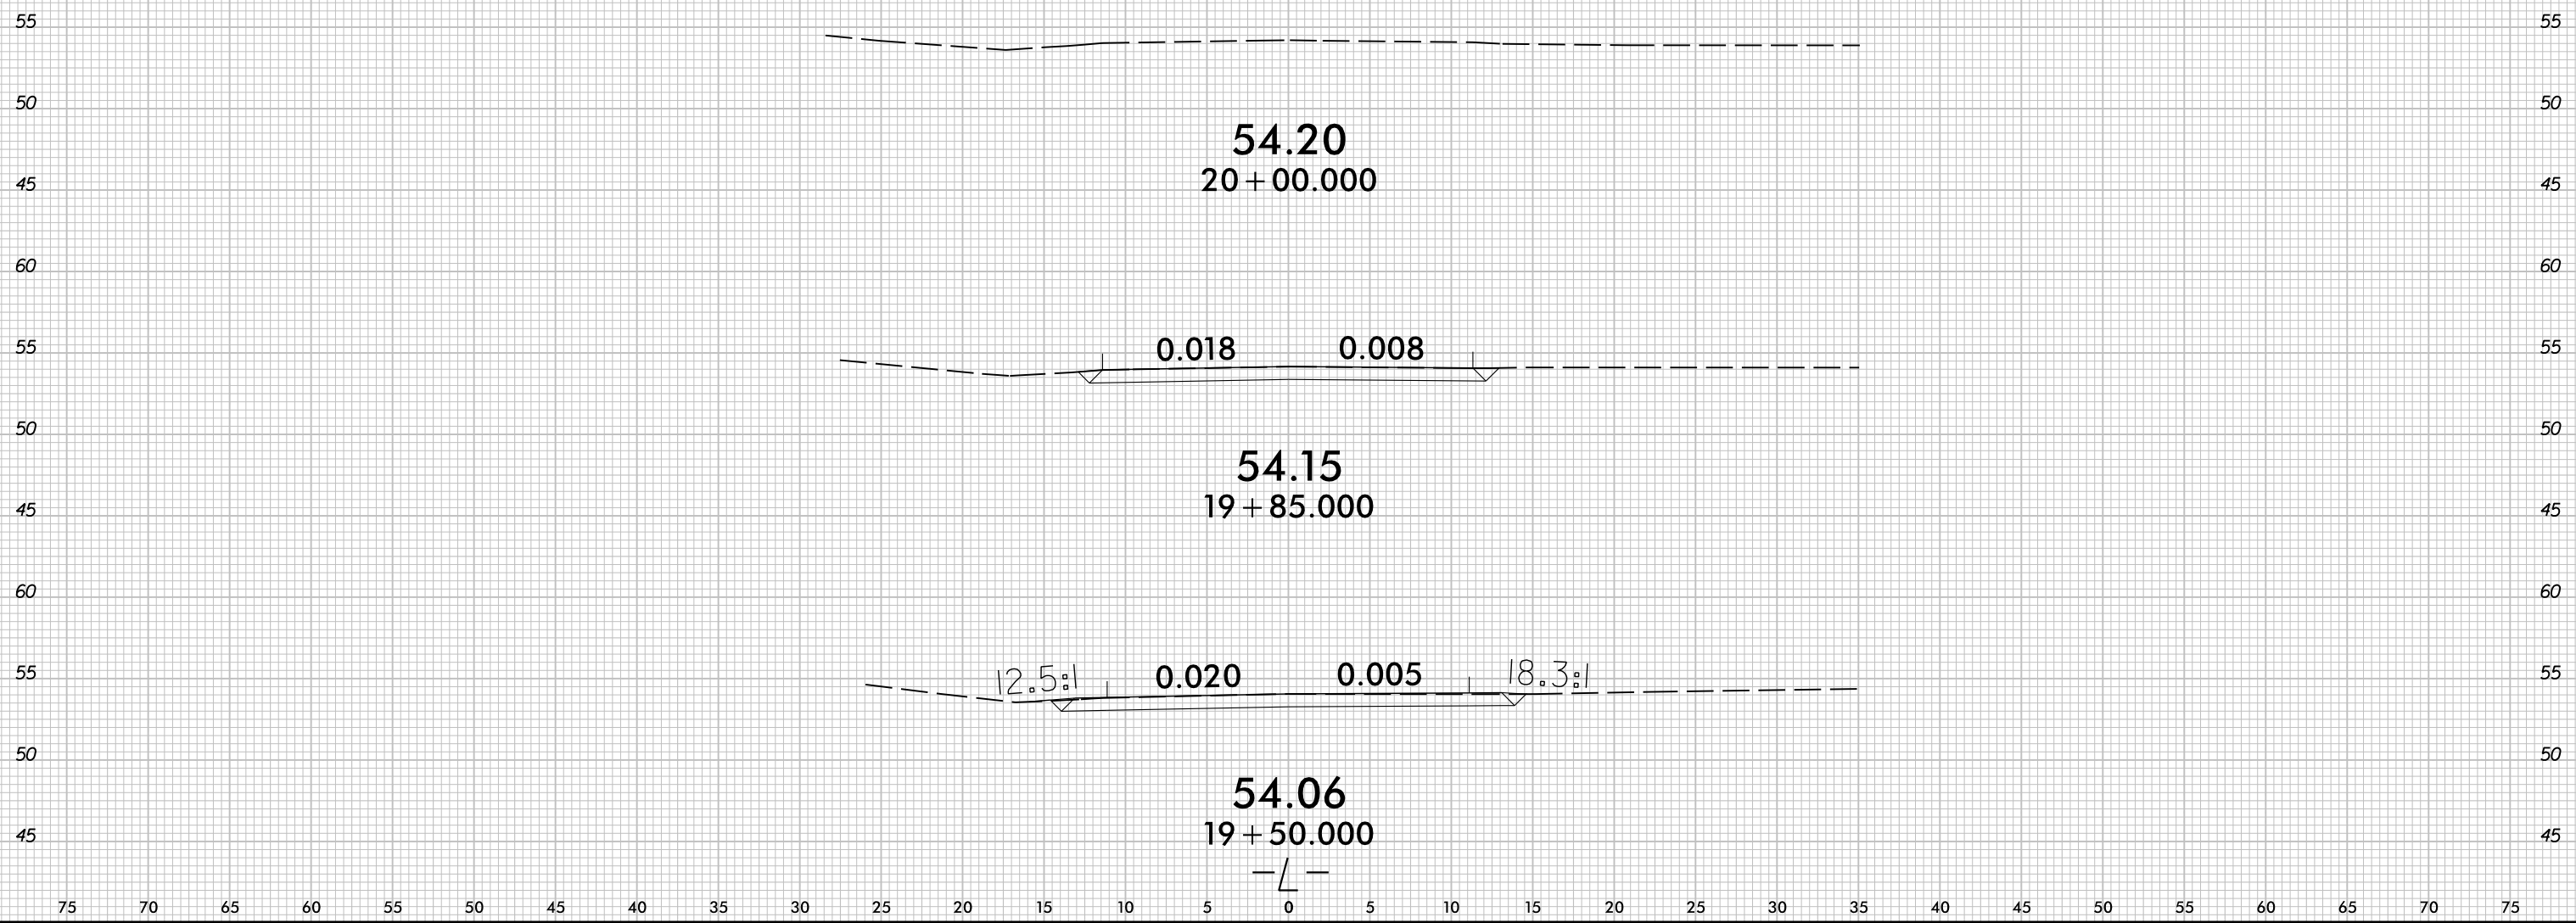
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B-5411


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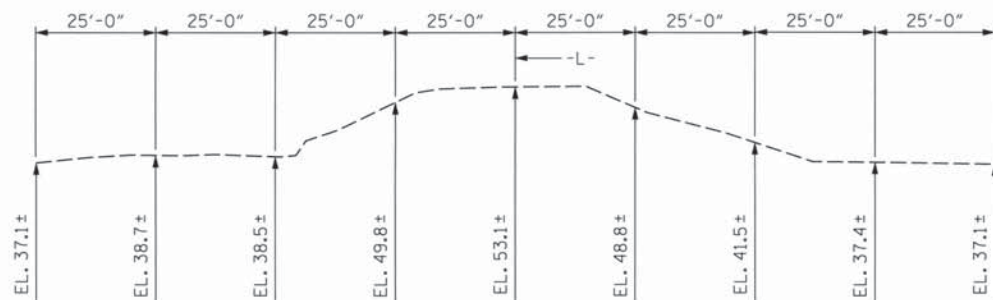
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LOCATION SKETCH

FOR UTILITY INFORMATION, SEE UTILITY PLANS AND SPECIAL PROVISIONS.



PROFILE ALONG THE C OF CULVERT

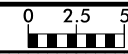NOTES

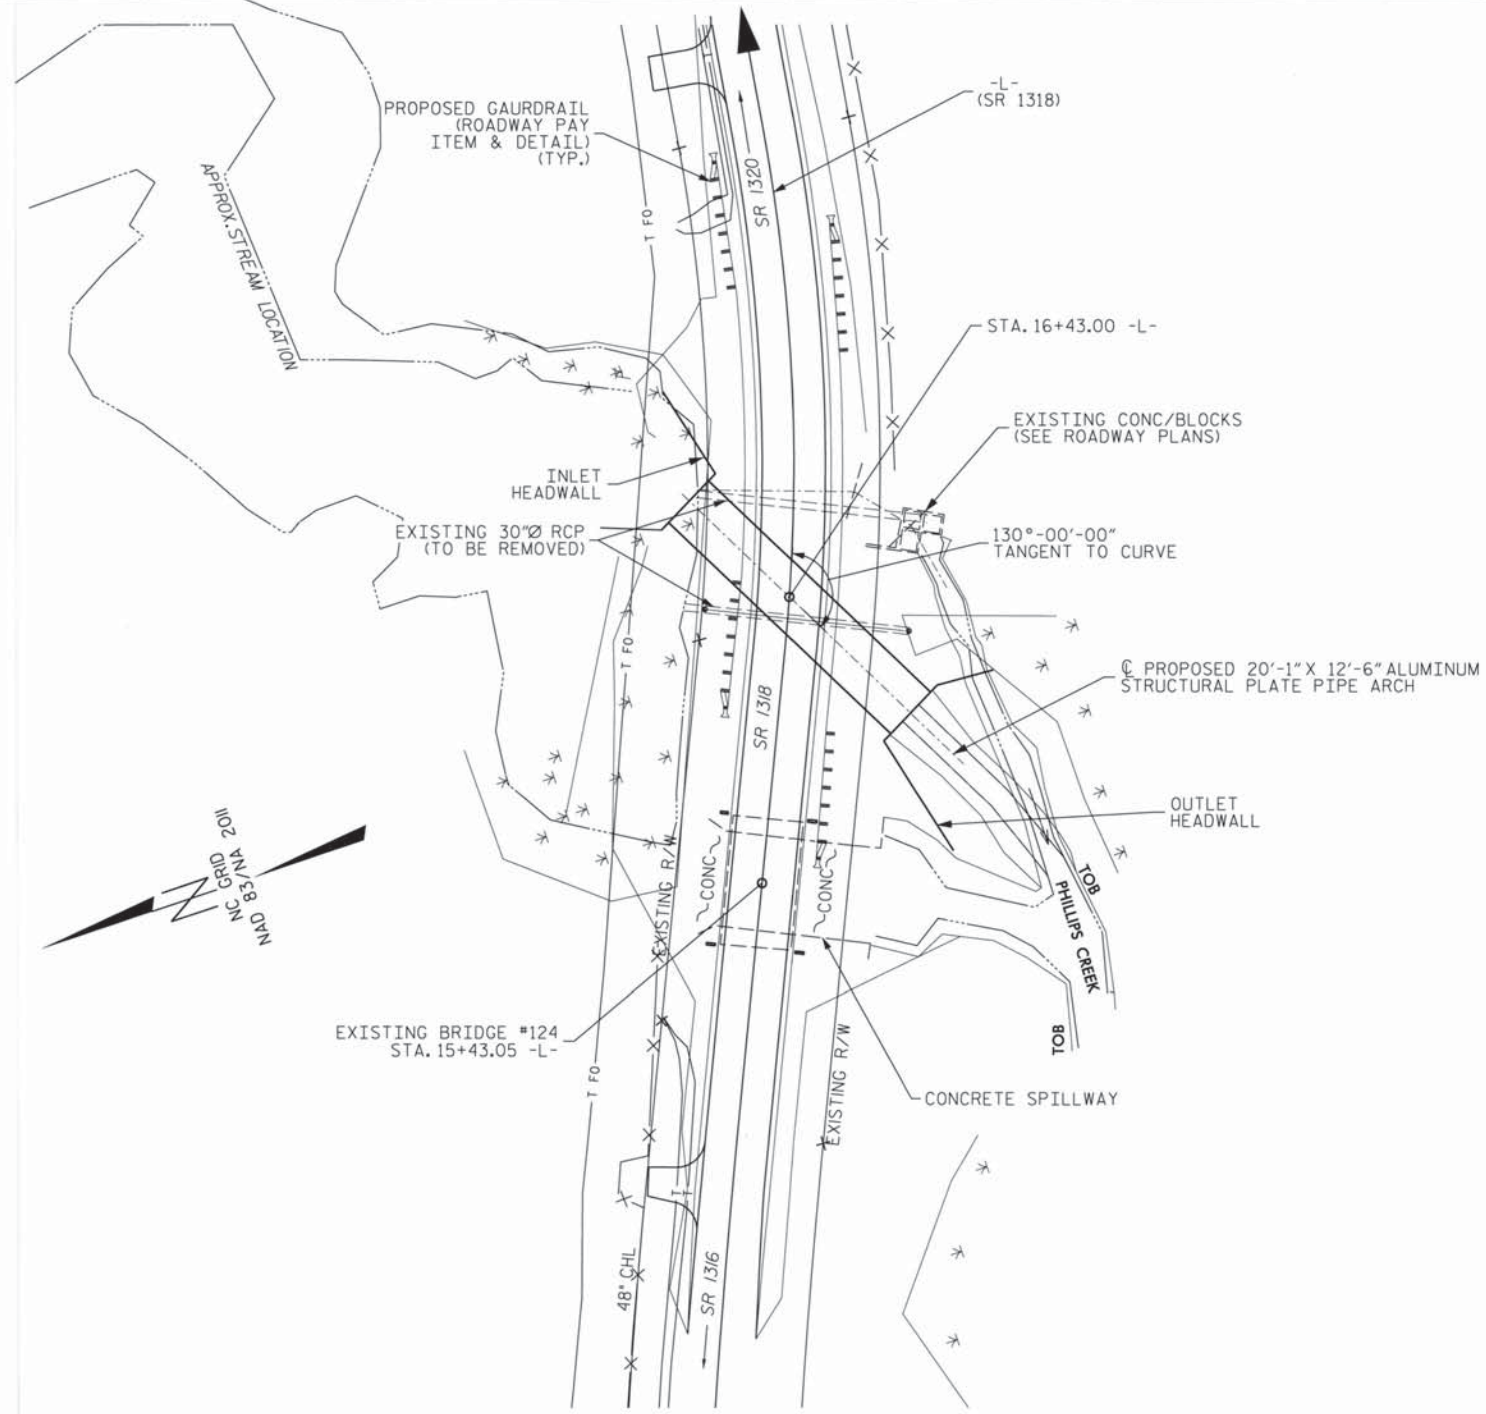- ASSUMED LIVE LOAD -----HL-93 OR ALTERNATE LOADING
- CULVERT IS TO BE DESIGNED FOR A MINIMUM FILL DEPTH OF 2'-0" AND A MAXIMUM OF 10'-0".
- FOR OTHER DESIGN AND GENERAL NOTES, SEE SHEET C-4.
- 3" Ø WEEP HOLES INDICATED TO BE IN ACCORDANCE WITH THE SPECIFICATIONS.
- THE RESIDENT ENGINEER SHALL CHECK THE LENGTH OF THE PIPE BEFORE STAKING IT OUT TO MAKE CERTAIN THAT IT WILL PROPERLY TAKE CARE OF THE FILL.
- FOR ALUMINUM STRUCTURAL PLATE PIPE ARCH CULVERT AND FOUNDATIONS, SEE SPECIAL PROVISIONS FOR ALUMINUM STRUCTURAL PLATE PIPE ARCH CULVERT.
- ALL MATERIALS SHALL MEET THE REQUIREMENTS OF THE NCDOT STANDARDS SPECIFICATIONS FOR ROADS AND STRUCTURES DATED JANUARY 2012.
- THE DETAILS SHOWN ARE FOR GENERAL LAYOUT ONLY. THE SUPPLIER SHALL PROVIDE DETAILS AND DESIGN FOR REVIEW AND APPROVAL THAT MEET THE REQUIREMENTS OF AASHTO LRFD BRIDGE DESIGN SPECIFICATIONS, SECTION 12, AND ARE SEALED BY A NORTH CAROLINA REGISTERED PROFESSIONAL ENGINEER.
- UNLESS OTHERWISE INDICATED, THE SUPPLIER SHALL DETAIL, DESIGN, AND FURNISH ALL STRUCTURAL ELEMENTS AND HARDWARE.
- GUARDRAIL POST LOCATIONS SHALL BE DETERMINED IN THE FIELD BY THE ENGINEER TO ENSURE ADEQUATE COVER AND INSTALLATION.
- FOR THE PLACEMENT OF SILLS WITHIN THE PIPE SEE DETAIL ON ROADWAY PLANS SHEET NO. 2.
- FOR SUBMITTAL OF WORKING DRAWINGS, SEE SPECIAL PROVISIONS.
- FOR CONSTRUCTION SEQUENCE SEE EROSION CONTROL PLANS.
- FOR FALSEWORK AND FORMWORK, SEE SPECIAL PROVISIONS.
- FOR CRANE SAFETY, SEE SPECIAL PROVISIONS.
- THE EXISTING STRUCTURE BRIDGE #124, CONSISTING OF ONE SPAN @ 47'-2" WITH A PRESTRESSED CONCRETE CORED SLAB SUPERSTRUCTURE AND A CLEAR ROADWAY WIDTH OF 24.8 FT. ON A SUBSTRUCTURE CONSISTING OF CONCRETE CAPS ON STEEL PILES AND 45" CONCRETE SPILLWAY, LOCATED AT STA. 15+43.05 -L- SHALL BE REMOVED.
- REMOVAL OF THE EXISTING STRUCTURE SHALL BE PERFORMED SO AS NOT TO ALLOW DEBRIS TO FALL INTO THE WATER. THE CONTRACTOR SHALL REMOVE THE STRUCTURE SPILLWAY AND SUBMIT PLANS FOR DEMOLITION IN ACCORDANCE WITH THE ARTICLE 402-2 OF THE STANDARD SPECIFICATIONS.

GRADE DATA

GRADE POINT EL. @ STA. 16+43.00 -L-	= EL. 53.58
BED EL. @ STA 16+43.00 -L-	= EL. 35.50
ROADWAY SLOPE	3:1

HYDRAULIC DATA

DESIGN DISCHARGE	= 800 C.F.S.
FREQUENCY OF DESIGN FLOOD	= 25 YRS.
DESIGN HIGH WATER ELEVATION	= 44.00
DRAINAGE AREA	= 7.2 SQ. MI.
BASE DISCHARGE (Q100)	= 1200 C.F.S.
BASE HIGH WATER ELEVATION	= 46.00

OVERTOPPING FLOOD DATA

* OVERTOPPING DISCHARGE = > 1,700 C.F.S.
 FREQUENCY OF OVERTOPPING FLOOD = 500 YRS. +
 OVERTOPPING FLOOD ELEVATION = 53.0 FT.
 * OVER TOPPING OCCURS @ CENTERLINE OF SAG -L- STA. 14+53.00 -L-


TOTAL STRUCTURE QUANTITIES

CULVERT EXCAVATION	----- LUMP SUM
REMOVAL OF EXISTING STRUCTURE	--- LUMP SUM
20'-1" X 12'-6", CAA STRUCTURAL PLATE PIPE ARCH W\ ALUMINUM HEADWALLS	----- LUMP SUM
#57 STONE	----- 3470 TONS
FLOWABLE FILL	----- 62 C.Y.

PROJECT NO. B-5411
BLADEN COUNTY
 STATION: 16+43.00 -L-

SHEET 1 OF 4 REPLACES BRIDGE NO. 124

STATE OF NORTH CAROLINA
 DEPARTMENT OF TRANSPORTATION
 RALEIGH
 SINGLE 20'-1" X 12'-6"
 ALUMINUM STRUCTURAL
 PLATE PIPE ARCH
 CULVERT
 130° SKEW

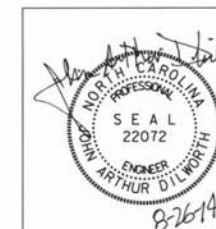

PLANS PREPARED BY:



559 Jones Franklin Rd. Suite 164
 Raleigh, N.C. 27606
 Bus: 919 851 8077
 Fax: 919 851 8107
 License No. F-0377

TRANSPORTATION PLANNING/DESIGN - BRIDGE/STRUCTURE DESIGN
 CIVIL/SITE DESIGN - GIS/GPS - CONSTRUCTION OBSERVATION


REVISIONS						SHEET NO.
NO.	BY:	DATE:	NO.	BY:	DATE:	C-1
1			3			TOTAL SHEETS
2			4			4

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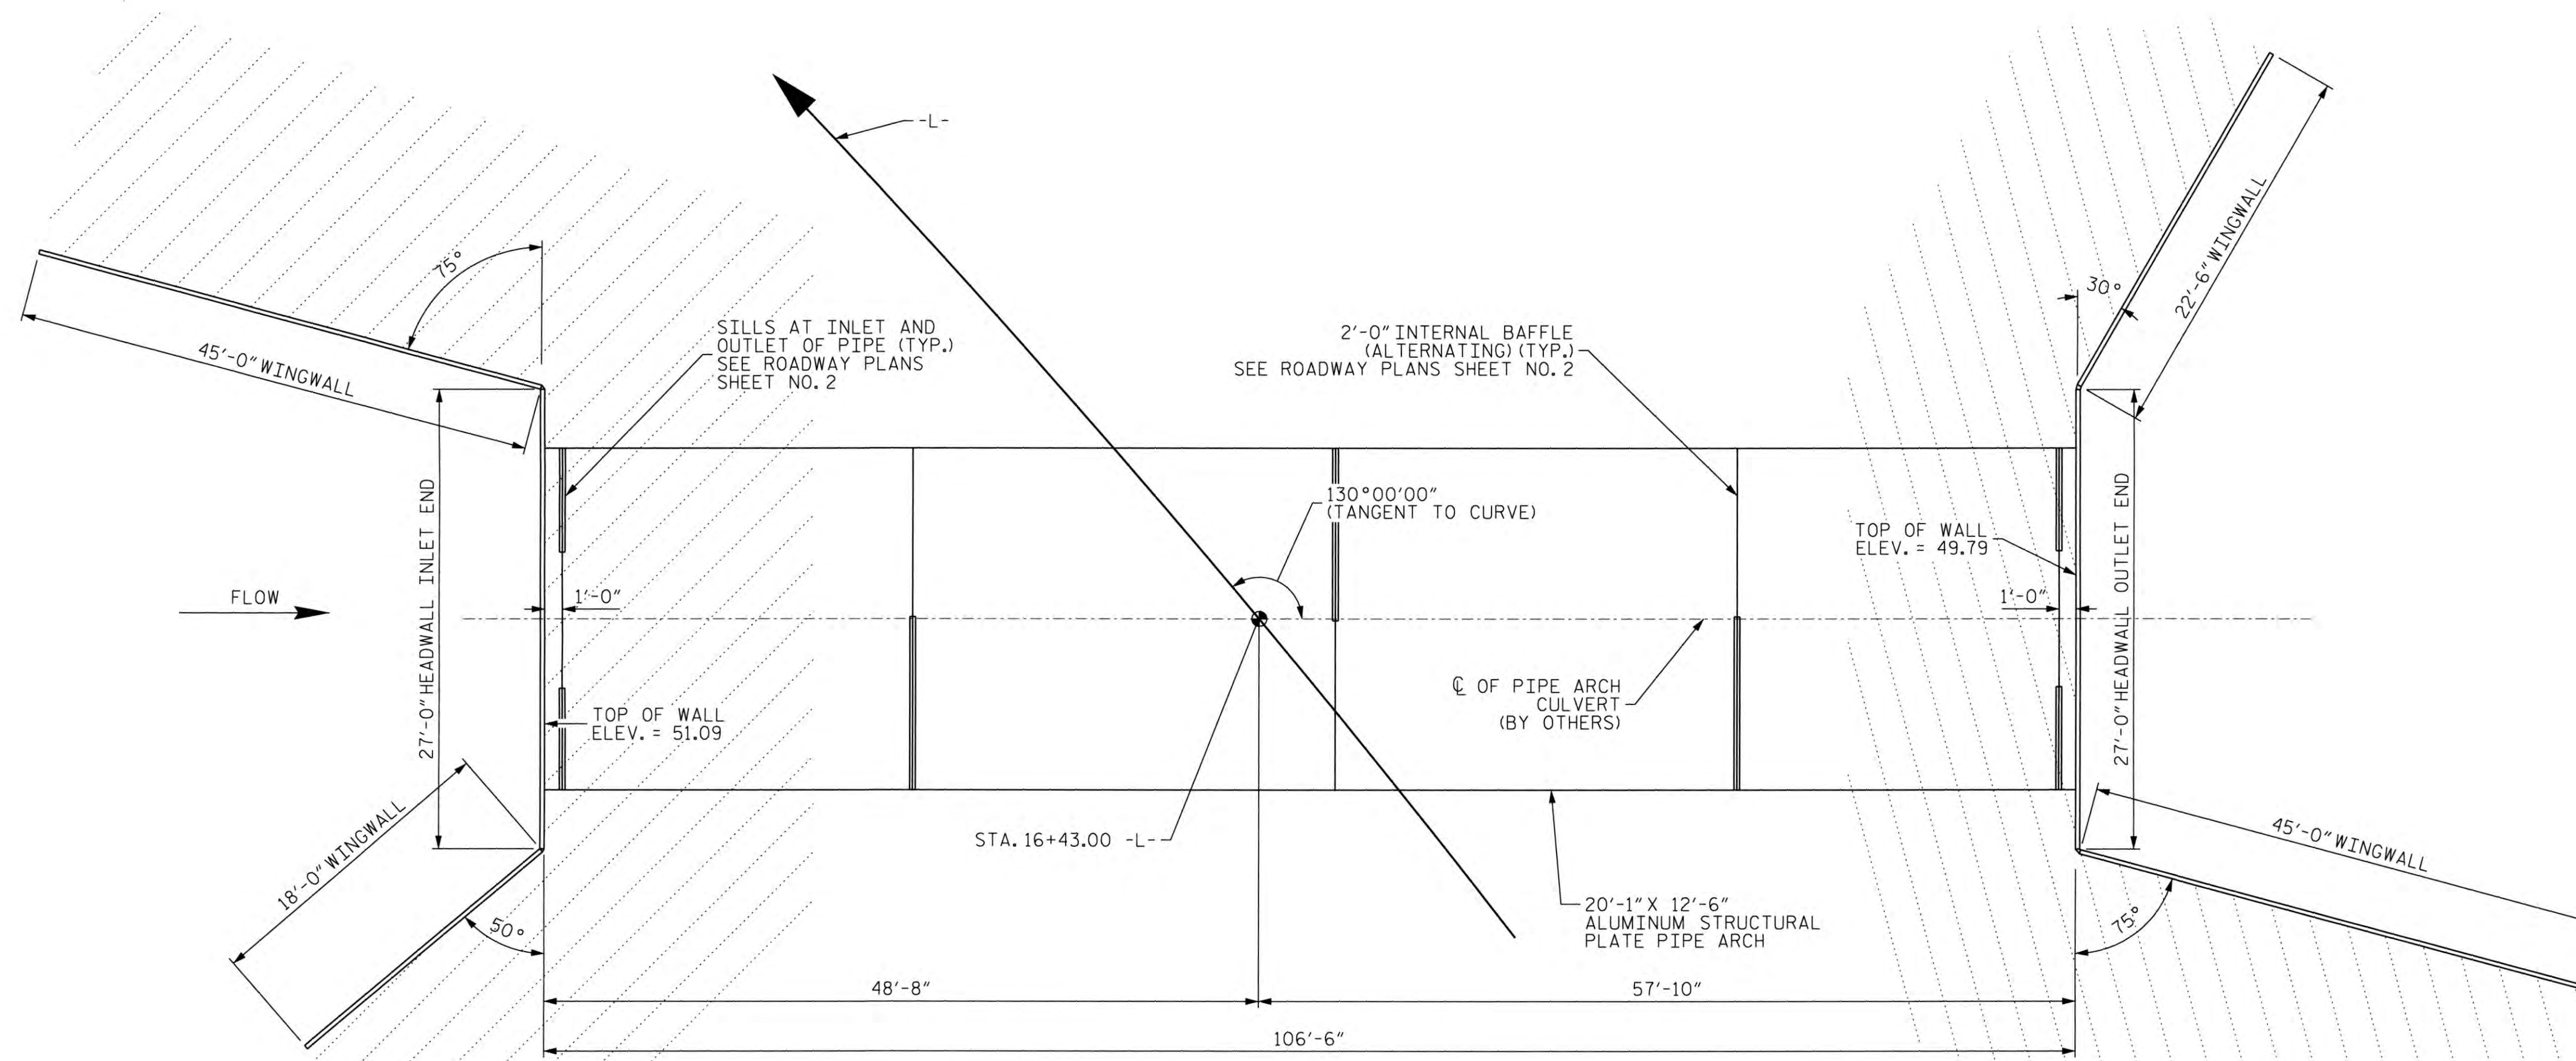
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 CHECKED BY: JAD DATE: 3-17-14
 DESIGN ENGINEER OF RECORD: JAD DATE: 3-17-14

NOTES

1. MINIMUM EMBEDMENT ALONG THE BASE OF WALL SHALL BE 3'-0", INCLUDING 2'-0" OF FLOWABLE FILL. SEE DETAIL SHEET C-4.
2. CONTRACTOR MUST SUBMIT SEALED SHOP DRAWINGS FOR PIPE & HEADWALLS TO NCDOT FOR APPROVAL PRIOR TO CONSTRUCTION.

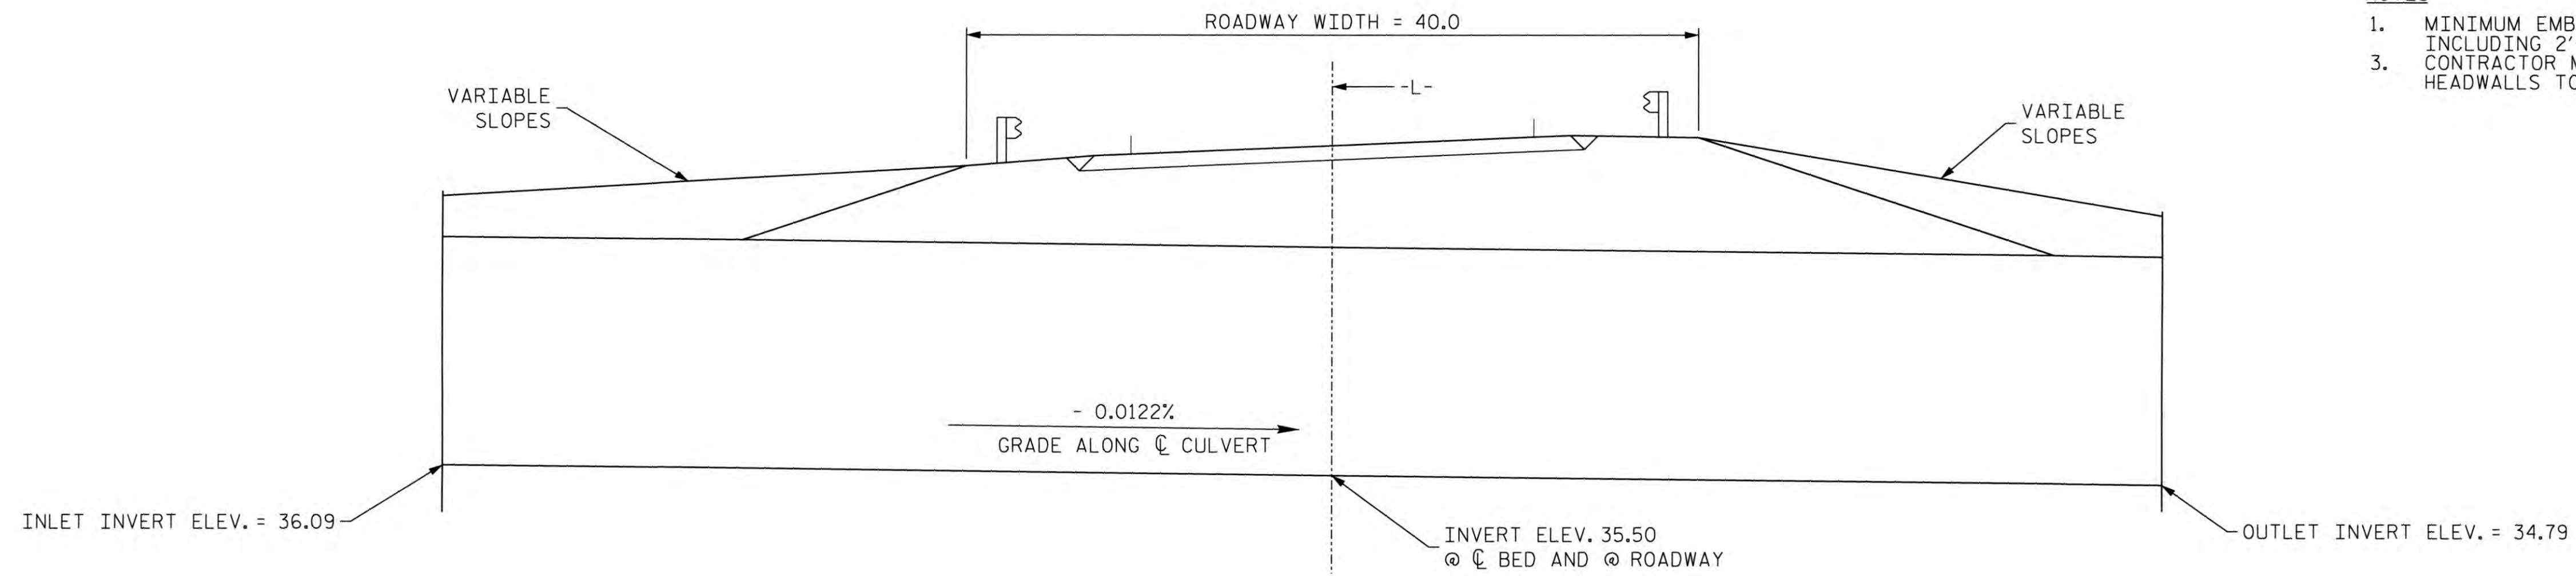

CULVERT SECTION NORMAL TO ROADWAY



PLAN VIEW

DIMENSIONS TO BE VERIFIED BY ENGINEER IN FIELD

BACKFILL #57 STONE

PROJECT NO. B-5411
BLADEN COUNTY
 STATION: 16+43.00 -L-

SHEET 2 OF 4

STATE OF NORTH CAROLINA
 DEPARTMENT OF TRANSPORTATION
 RALEIGH
 SINGLE 20'-1" X 12'-6"
 ALUMINUM STRUCTURAL
 PLATE PIPE ARCH
 CULVERT
 130° SKEW



PLANS PREPARED BY:




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REVISIONS						SHEET NO.
NO.	BY:	DATE:	NO.	BY:	DATE:	C-2
1			3			TOTAL SHEETS
2			4			4


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 DESIGN ENGINEER OF RECORD: JAD DATE: 3-17-14



INLET HEADWALL ELEVATION - LOOKING DOWNSTREAM

DIMENSIONS TO BE VERIFIED BY ENGINEER IN THE FIELD.
 BOTTOM OF WINGWALLS AND HEADWALL TO BE EMBEDDED AND
 CAST IN FLOWABLE FILL. SEE FLOWABLE FILL DETAIL ON SHEET C-4

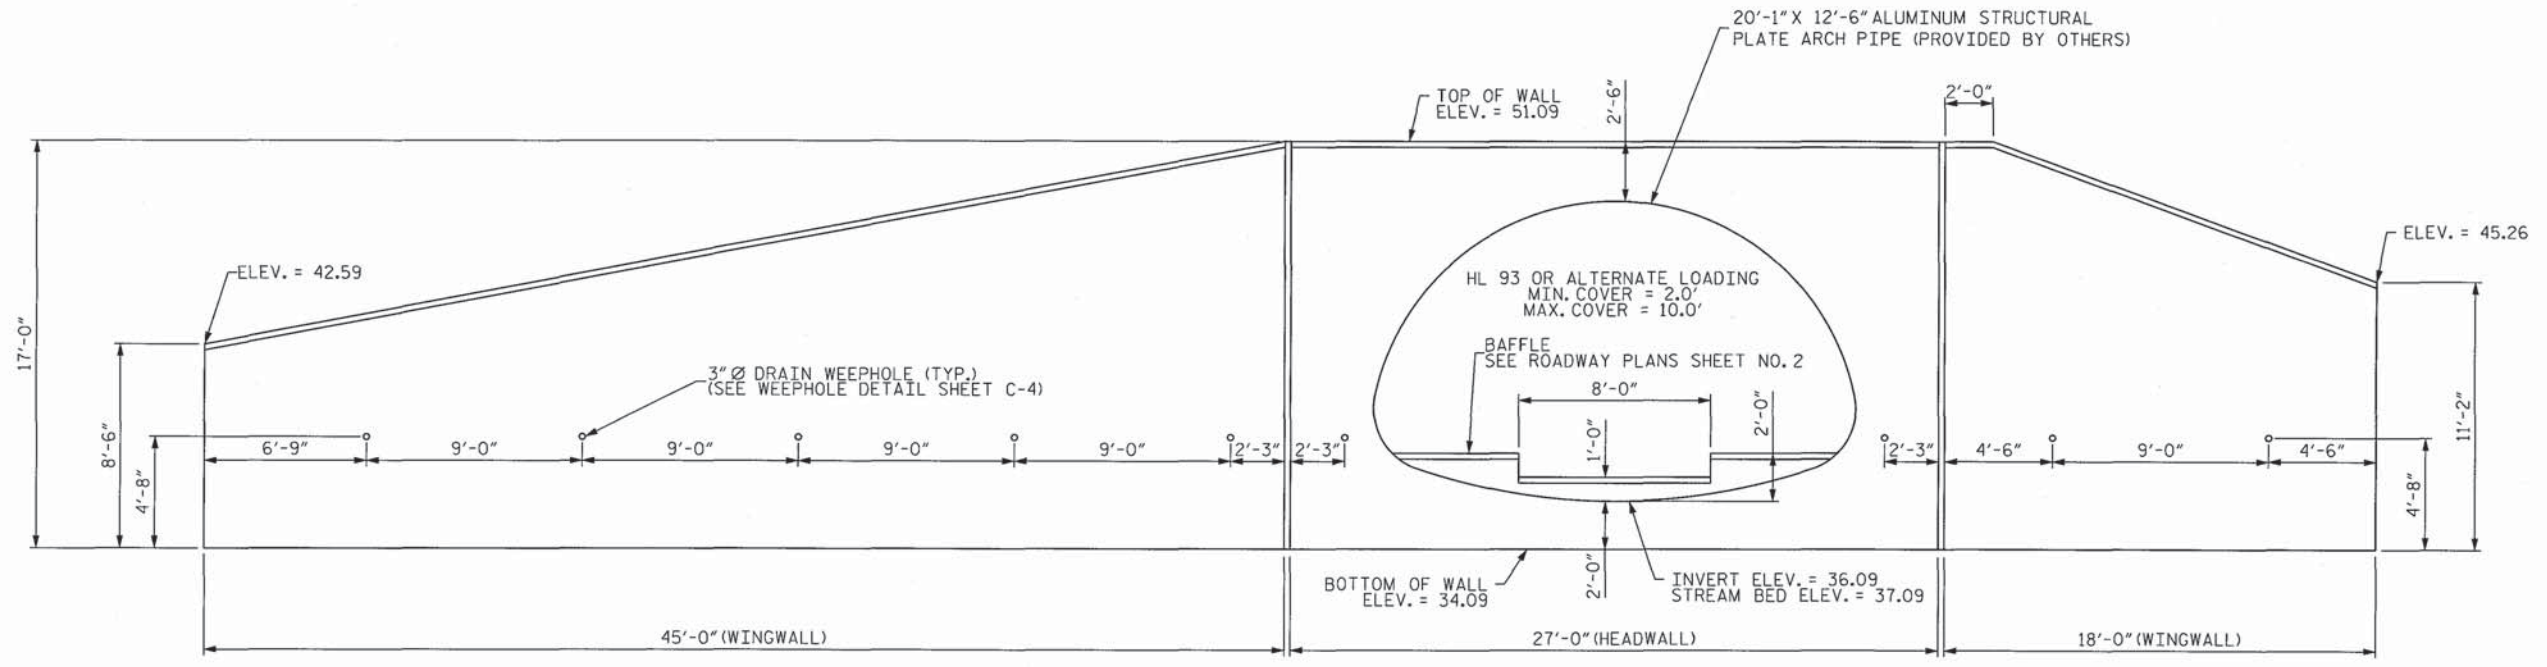

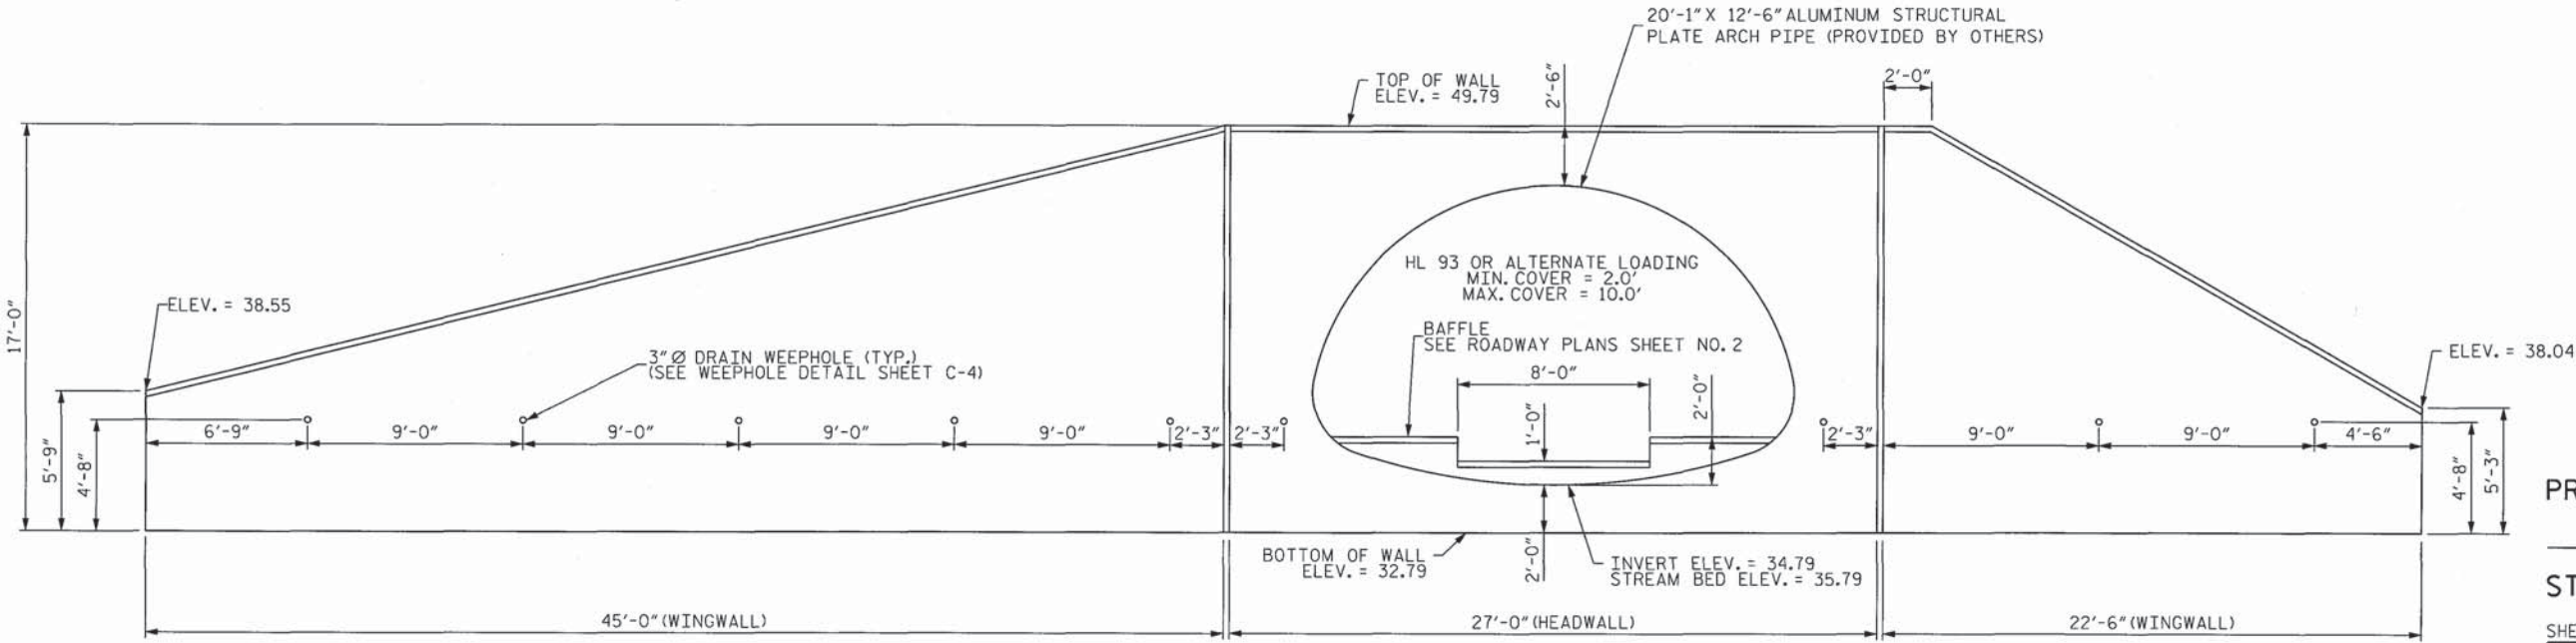OUTLET HEADWALL ELEVATION - LOOKING UPSTREAM

DIMENSIONS TO BE VERIFIED BY ENGINEER IN THE FIELD.
 BOTTOM OF WINGWALLS AND HEADWALL TO BE EMBEDDED AND
 CAST IN FLOWABLE FILL. SEE FLOWABLE FILL DETAIL ON SHEET C-4

PROJECT NO. B-5411
BLADEN COUNTY
 STATION: 16+43.00 -L-
 SHEET 3 OF 4

STATE OF NORTH CAROLINA
 DEPARTMENT OF TRANSPORTATION
 RALEIGH
 SINGLE 20'-1" X 12'-6"
 ALUMINUM STRUCTURAL
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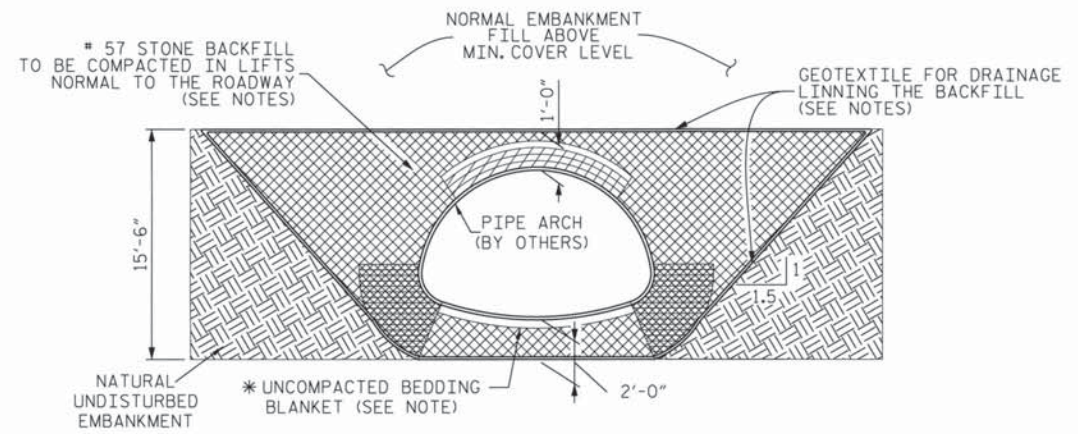
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REVISIONS						SHEET NO.
NO.	BY:	DATE:	NO.	BY:	DATE:	C-3
1			3			TOTAL SHEETS
2			4			4

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 CHECKED BY: JAD DATE: 3-17-14
 DESIGN ENGINEER OF RECORD: JAD DATE: 3-17-14

NOTE
 CONTRACTOR MUST SUBMIT SEALED SHOP DRAWINGS FOR PIPE & HEADWALLS TO NCDOT FOR APPROVAL PRIOR TO CONSTRUCTION.




- CRITICAL BACKFILL ZONE, PRESSURE ON SOIL GREATEST HERE.
- INITIAL LIFTS OVER CROWN OF STRUCTURE AS INDICATED BY SHADED AREA TO BE COMPACTED TO REQUIRED DENSITY WITH HAND OPERATED EQUIPMENT OR WITH SMALL TRACTOR (D-4 OR SMALLER) DRAWN EQUIPMENT.
- # 57 STONE BACKFILL LIMITS.

NOTES:
 ALL BACKFILL TO BE PLACED IN A BALANCED FASHION IN THIN LIFTS (6"-8" LOOSE TYPICALLY) AND COMPACTED TO 90 PERCENT DENSITY PER AASHTO T-180.
 GEOTEXTILE FOR DRAINAGE IN FOUNDATION BEDDING AND BACKFILL IS INCIDENTAL TO COST OF PIPE ARCH.
 COMPLETE AND REGULAR MONITORING OF THE CSP ARCH SHAPE IS NECESSARY DURING ALL BACKFILLING OF THE STRUCTURE.
 PREVENT EXCESSIVE DISTORTION OF SHAPE AS NECESSARY BY VARYING COMPACTION METHODS AND EQUIPMENT.
 * SHAPED BED FOR A MINIMUM WIDTH OF SPAN/2. MINIMUM BEDDING THICKNESS IS TWICE THE CORRUGATION DEPTH.
 EMBANKMENT SLOPE TO BE 1.5:1 MINIMUM SUCH THAT A STABLE EMBANKMENT CAPABLE OF RESISTING SIDE PRESSURES FROM CSP PIPE-ARCH SHAPE WILL BE MAINTAINED THROUGHOUT THE LIFE OF INSTALLATION.


TYPICAL BACKFILL SECTION ALONG PIPE

NTS

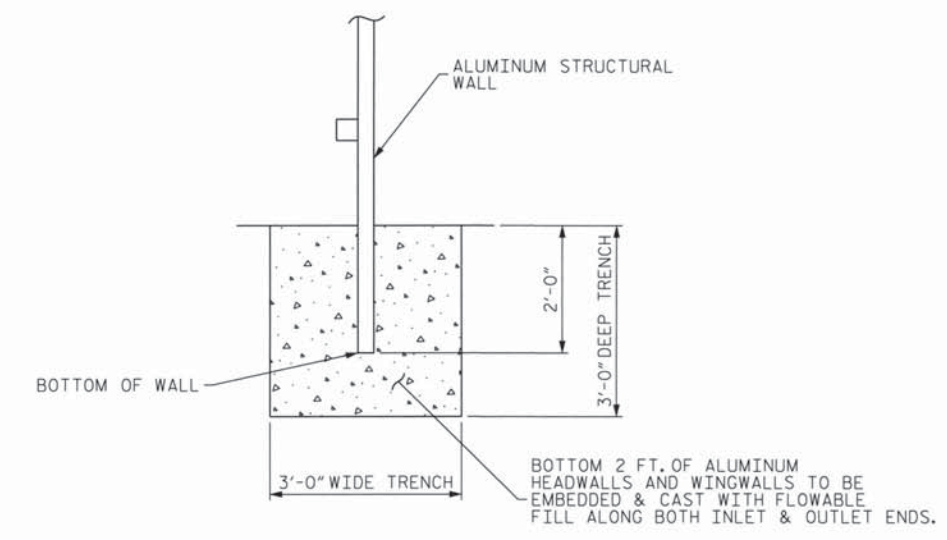

FLOWABLE FILL DETAIL

NTS

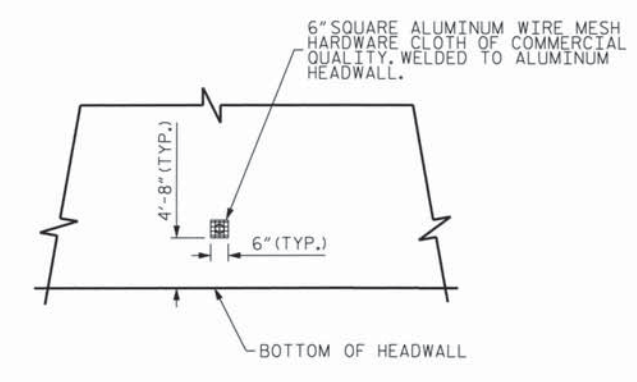

WEEPHOLE DETAIL

NTS

PROJECT NO. B-5411
BLADEN COUNTY
 STATION: 16+43.00 -L-

SHEET 4 OF 4

STATE OF NORTH CAROLINA
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 ALUMINUM STRUCTURAL
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8-26-14

REVISIONS						SHEET NO.
NO.	BY:	DATE:	NO.	BY:	DATE:	C-4
1			3			TOTAL SHEETS
2			4			4

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